CALCULATIONS WERE DONE USING RATIONAL METHOD Q = C i A WHERE:

- Q = RUNOFF IN cfs (L/s, m^3/s)
- C = RUNOFF COEFFICIENT
- i = RAINFALL INTENSITY IN in/hr
 A = AREA IN acres (m², ha)

PRE-DEVELOPMENT (ALLOWABLE) DISCHARGE RATE WAS CALCULATED FOR 5-YEAR STORM USING TIME OF CONCENTRATION OF 10 MIN AND ACCORDING TO THE RAINFALL INTENSITY EQUATION OUTLINED IN MACLAREN 1974 DRAINAGE CRITERIA MANUAL FOR THE CITY OF WINNIPEG.


• C = 0.5 (SUPPLIED BY CITY OF WINNIPEG)

- i = 109.50 mm/hr
- A ENTIRE CATCHMENT = 994.053 m², 0.099 ha
- Q PRE-DEVELOPMENT (ALLOWABLE) = $(0.5) * (109.50 \text{ mm/hr}) * (0.099 \text{ hg}) = 15.117 \text{ L/s}, 0.015117 \text{ m}^3/\text{s}$


POST-DEVELOPMENT DISCHARGE THROUGH A 70mm DIAMETER RESTRICTOR ORIFICE

• $Q_0 = (Cd * (2*g*h))*(3.14*(r^2)) = ((0.62)* (2*9.81m/s*(231.87m-229.85m)^0.5))*(3.14*(0.035^2) = 0.0150211m^3/s$, 15.021L/s • A 70 mm DIAMETER ORIFICE SHALL BE INSERTED INTO THE SOUTH EAST 250¢ PIPE OF MH 2 PER DETAIL ON THIS SHEET.

REQUIRED 25-YEAR STORAGE VOLUME FOR SITE DETERMINED USING ISOCHRONE METHOD FOR THE TOTAL RESTRICTED AREA OF PROPERTY 994.053m² AS SHOWN IN THE STORMWATER KEY PLAN. POST-DEVELOPMENT CONDITIONS, AND RESTRICTED RUNOFF RATE OF 15.021 L/s A MINIMUM OF 16.56m³ IS REQUIRED. TEMPORARY STORAGE VOLUME IS ACHIEVED IN UNDERGROUND 1800Ø MANHOLE, 250Ø AND 300Ø LAND DRAINAGE,PIPE. STORAGE TOTALING 17.89m³ AT PONDING ELEVATION 231.870m. WHICH IS GREATER THAN THE REQUIRED 16.56m³ THEREFORE, THE CITY TEMPORARY STORAGE REQUIREMENTS ARE MET.

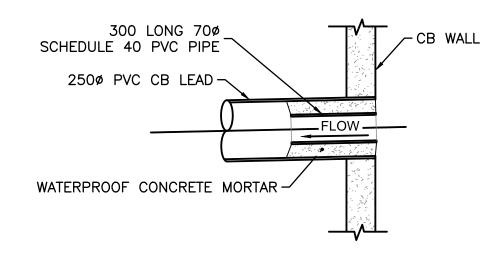

RESTRICTION PIPE DETAIL (AS PER SD-025B)

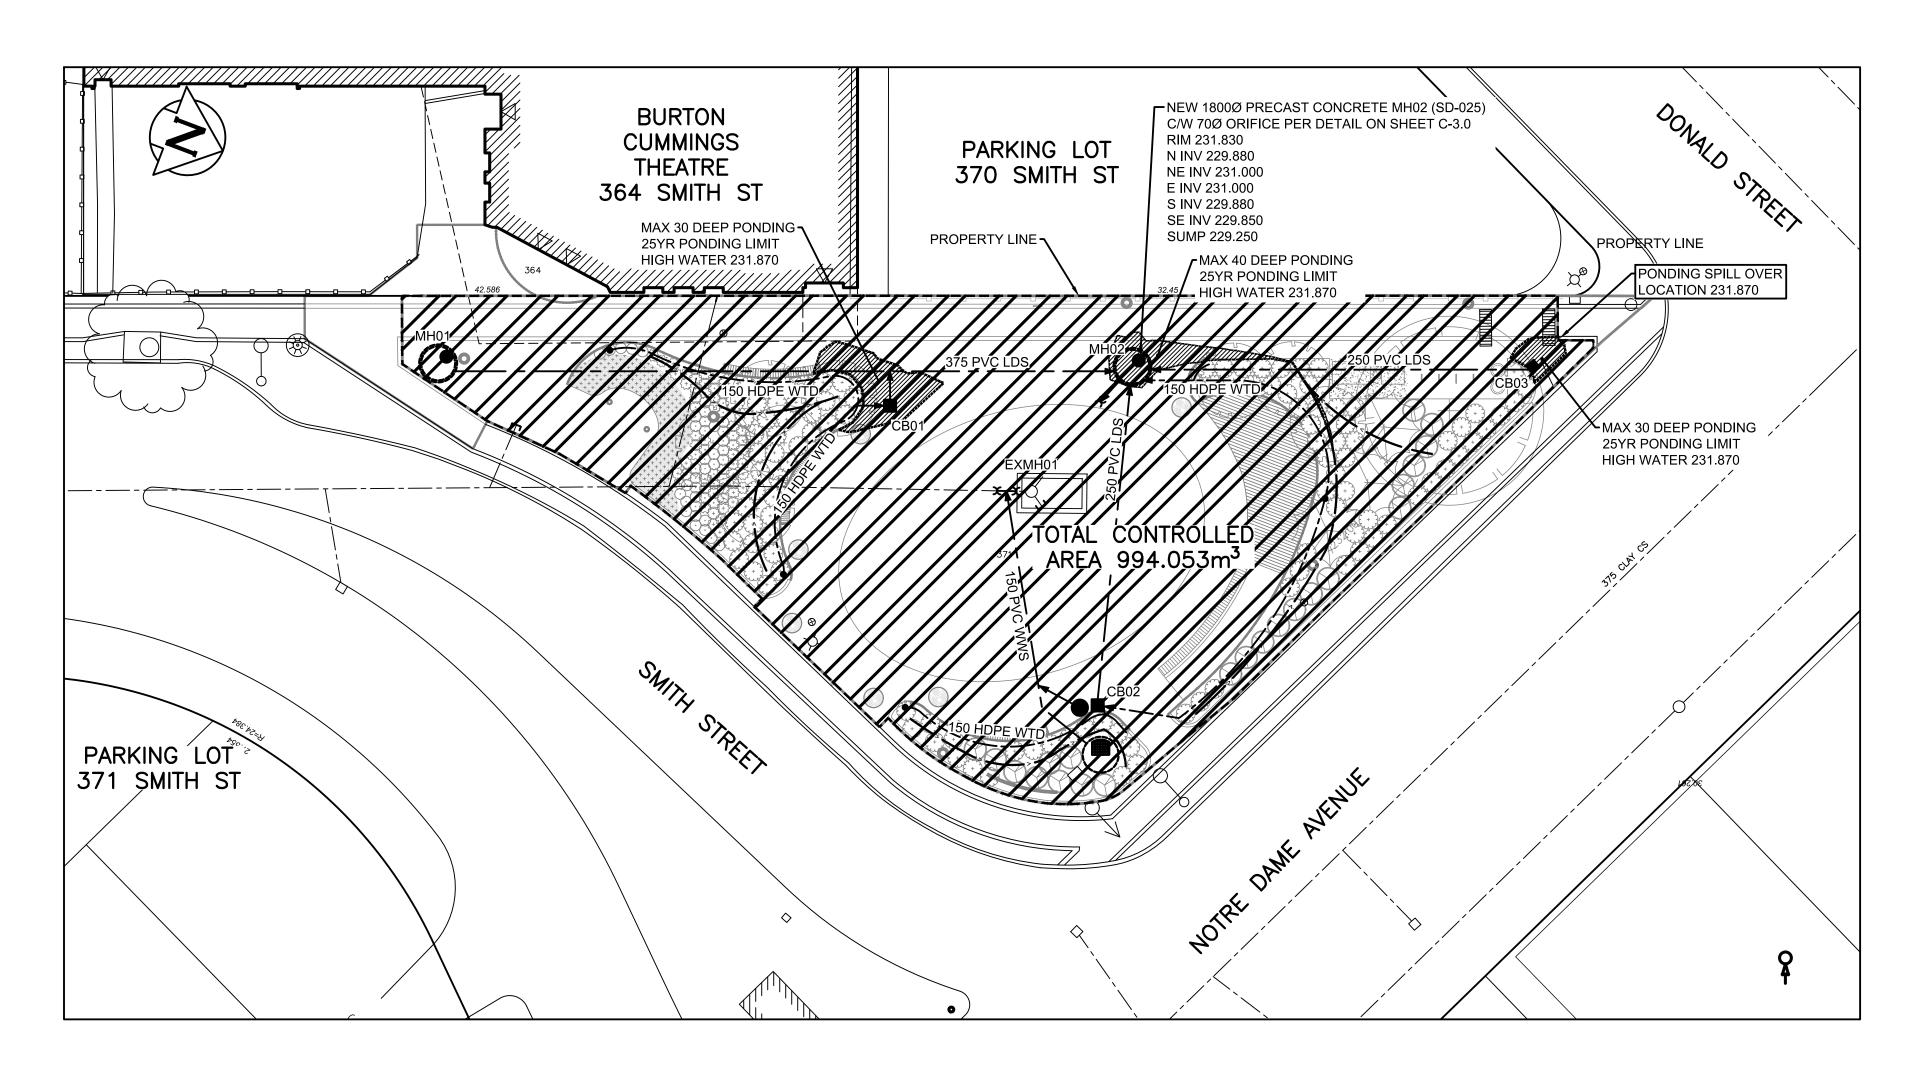

POST-DEVELOPMENT STORMWATER MANAGEMENT KEYPLAN SCALE: 1:200

-70										
01(300 LDS	LAND DRAINAGE SEWER	300 LDS	—×— X —×—	FENCE		⊶ ●	LIGHT STANDARD	•• •	
4-	<u>250 WWS</u>	WASTE WATER SEWER	250 WWS	—·—>—·—	SWALE	>	○→	TRAFFIC SIGNAL		
72		GAS					0.0%	SLOPE	0.0%	LOCATION APPROVED
012		HYDRO			BACK OF CURB					UNDERGROUND STRUCTURES
7—(· · ·	M.T.S.	—··		ASPHALT MILL & FILL					ONDERGROUND STRUCTURES
OHMG	1 <u>50_WM</u>	WATER MAIN	<u>150 WM</u>		ASPHALT					SUPV. U/G STRUCTURES DATE
l Yıl	-	HYDRANT	+		CONCRETE	4 4				COMMITTEE DATE
<u>γ</u> .2942	\otimes	VALVE	⊗							NOTE:
ZAMBOK-201	0	MANHOLE	•		LANDSCAPING	<u> </u>				LOCATION OF UNDERGROUND STRUCTURES AS
<u>k</u>		CATCH BASIN			PROPERTY LINE					SHOWN ARE BASED ON THE BEST INFORMATION AVAILABLE BUT NO GUARANTEE IS GIVEN
ande:	∇	CURB INLET	▼	•	TEST HOLE					THAT ALL EXISTING UTILITIES ARE SHOWN OR THAT THE GIVEN LOCATIONS ARE EXACT.
B G C	● ^H	POLES T-MTS H-HYDRO		igtriangle	GEODETIC BENCHMARK					CONFIRMATION OF EXISTENCE AND EXACT
	\dashv	GUY WIRE		231.33	ELEVATION	231.333				LOCATION OF ALL SERVICES MUST BE OBTAINED FROM THE INDIVIDUAL UTILITIES
Fitte	EXISTING	LEGEND-PLAN	PROPOSED	EXISTING	LEGEND-PLAN	PROPOSED	EXISTING	LEGEND-PLAN	PROPOSED	BEFORE PROCEEDING WITH CONSTRUCTION.

WARNING

NOTIFY THE GAS COMPANY OF THE PROPOSED LOCATION OF EXCAVATION.

TAKE PRECAUTION TO AVOID DAMAGE TO GAS COMPANY INSTALLATIONS.

SEE PROVINCIAL REGULATION 210/72 FOR

PROPERTY LIMITS DELINEATION


DELINEATION OF PROPERTY LIMITS AS SHOWN ON THIS DWG DOES NOT REPRESENT A "LEGAL SURVEY". KGS GROUP MAKES NO REPRESENTATION OR WARRANTY AS TO THE ACCURACY OF PROPERTY LIMITS DELINEATED ON THIS DWG, NOR ON THE DIMENSIONAL ACCURACY OF DWG FEATURES RELATIVE

TO THOSE PROPERTY LIMITS.

METRIC
WHOLE NUMBERS INDICATE MILLIMETRES
DECIMALIZED NUMBERS INDICATE METRES

KGS

NOTES:

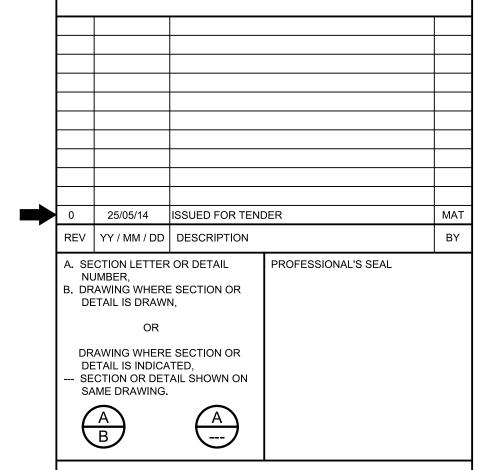

SCATLIFF + MILLER + MURRAY

visionary urban design + landscapes

CONSULTANT FILE NAME 24-0107-012_C.dwg

CITY OF WINNIPEG



ODEON PARK REDEVELOPMENT

CITY DRAWING NUMBER SHEET OF

- 1 1

CIVIL NEW SITE PLAN

DESIGN DRAWN DATE-Y/M/D SCALE
GLG GLG 25/05/14 AS NOTED
CHECKED APPROVED PROJECT No. DRAWING No.
MAT MAT 24-0107-012 C3.0

BID OPPORTUNITY No. xx-xxxx