


1 PIER CAP PLAN

1 : 50

- EXISTING PIER N-1 SHOWN, N-2 N-3, N-4 SIMILAR
- FOR SURFACE MOUNTED UNDERBRIDGE LIGHTING FIXTURES AND CONDUITS, REFER TO ELECTRICAL DRAWINGS FOR DETAILS


PIER BEARING SEAT DIMENSIONS				
PIER LOCATION	"A"	"B"	"C"	"D"
N-1	26	26	26	26
N-2	35	35	35	35
N-3	47	47	47	47
N-4	46	46	46	46

NOTE:
SEAT DIMENSIONS TO BE VERIFIED WITH EXISTING PIER SEAT DIMENSIONS. ANY DISCREPANCIES TO BE REPORTED TO ENGINEER.

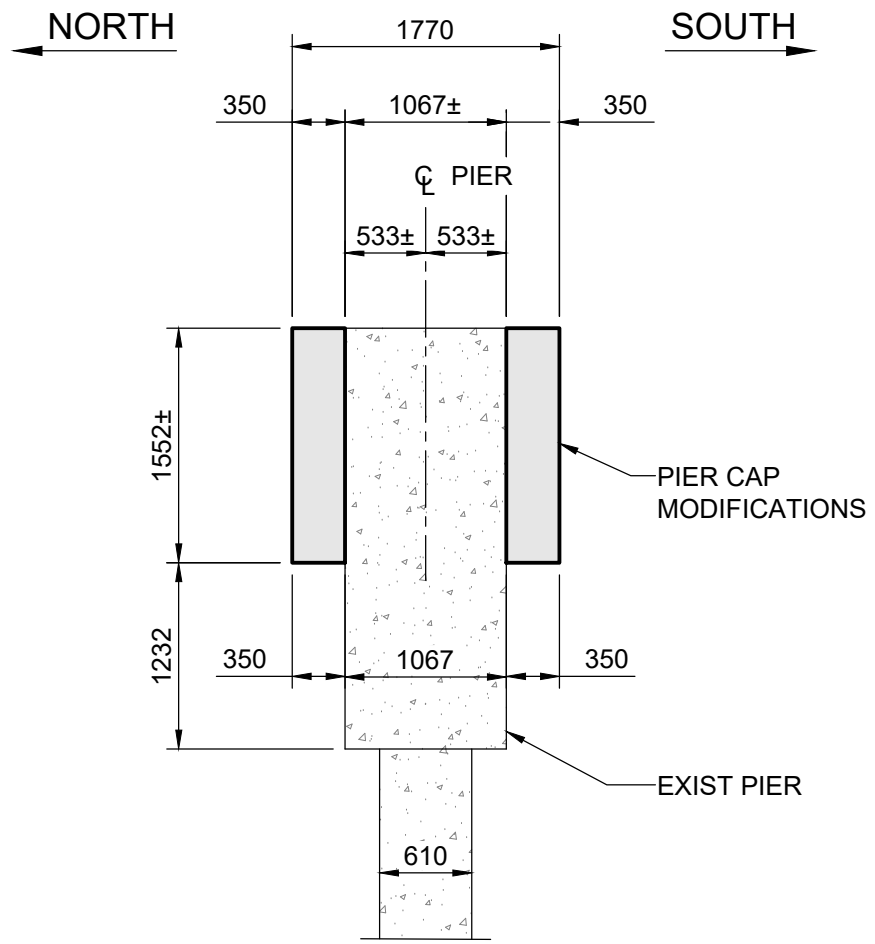

4 SECTION


1 : 50

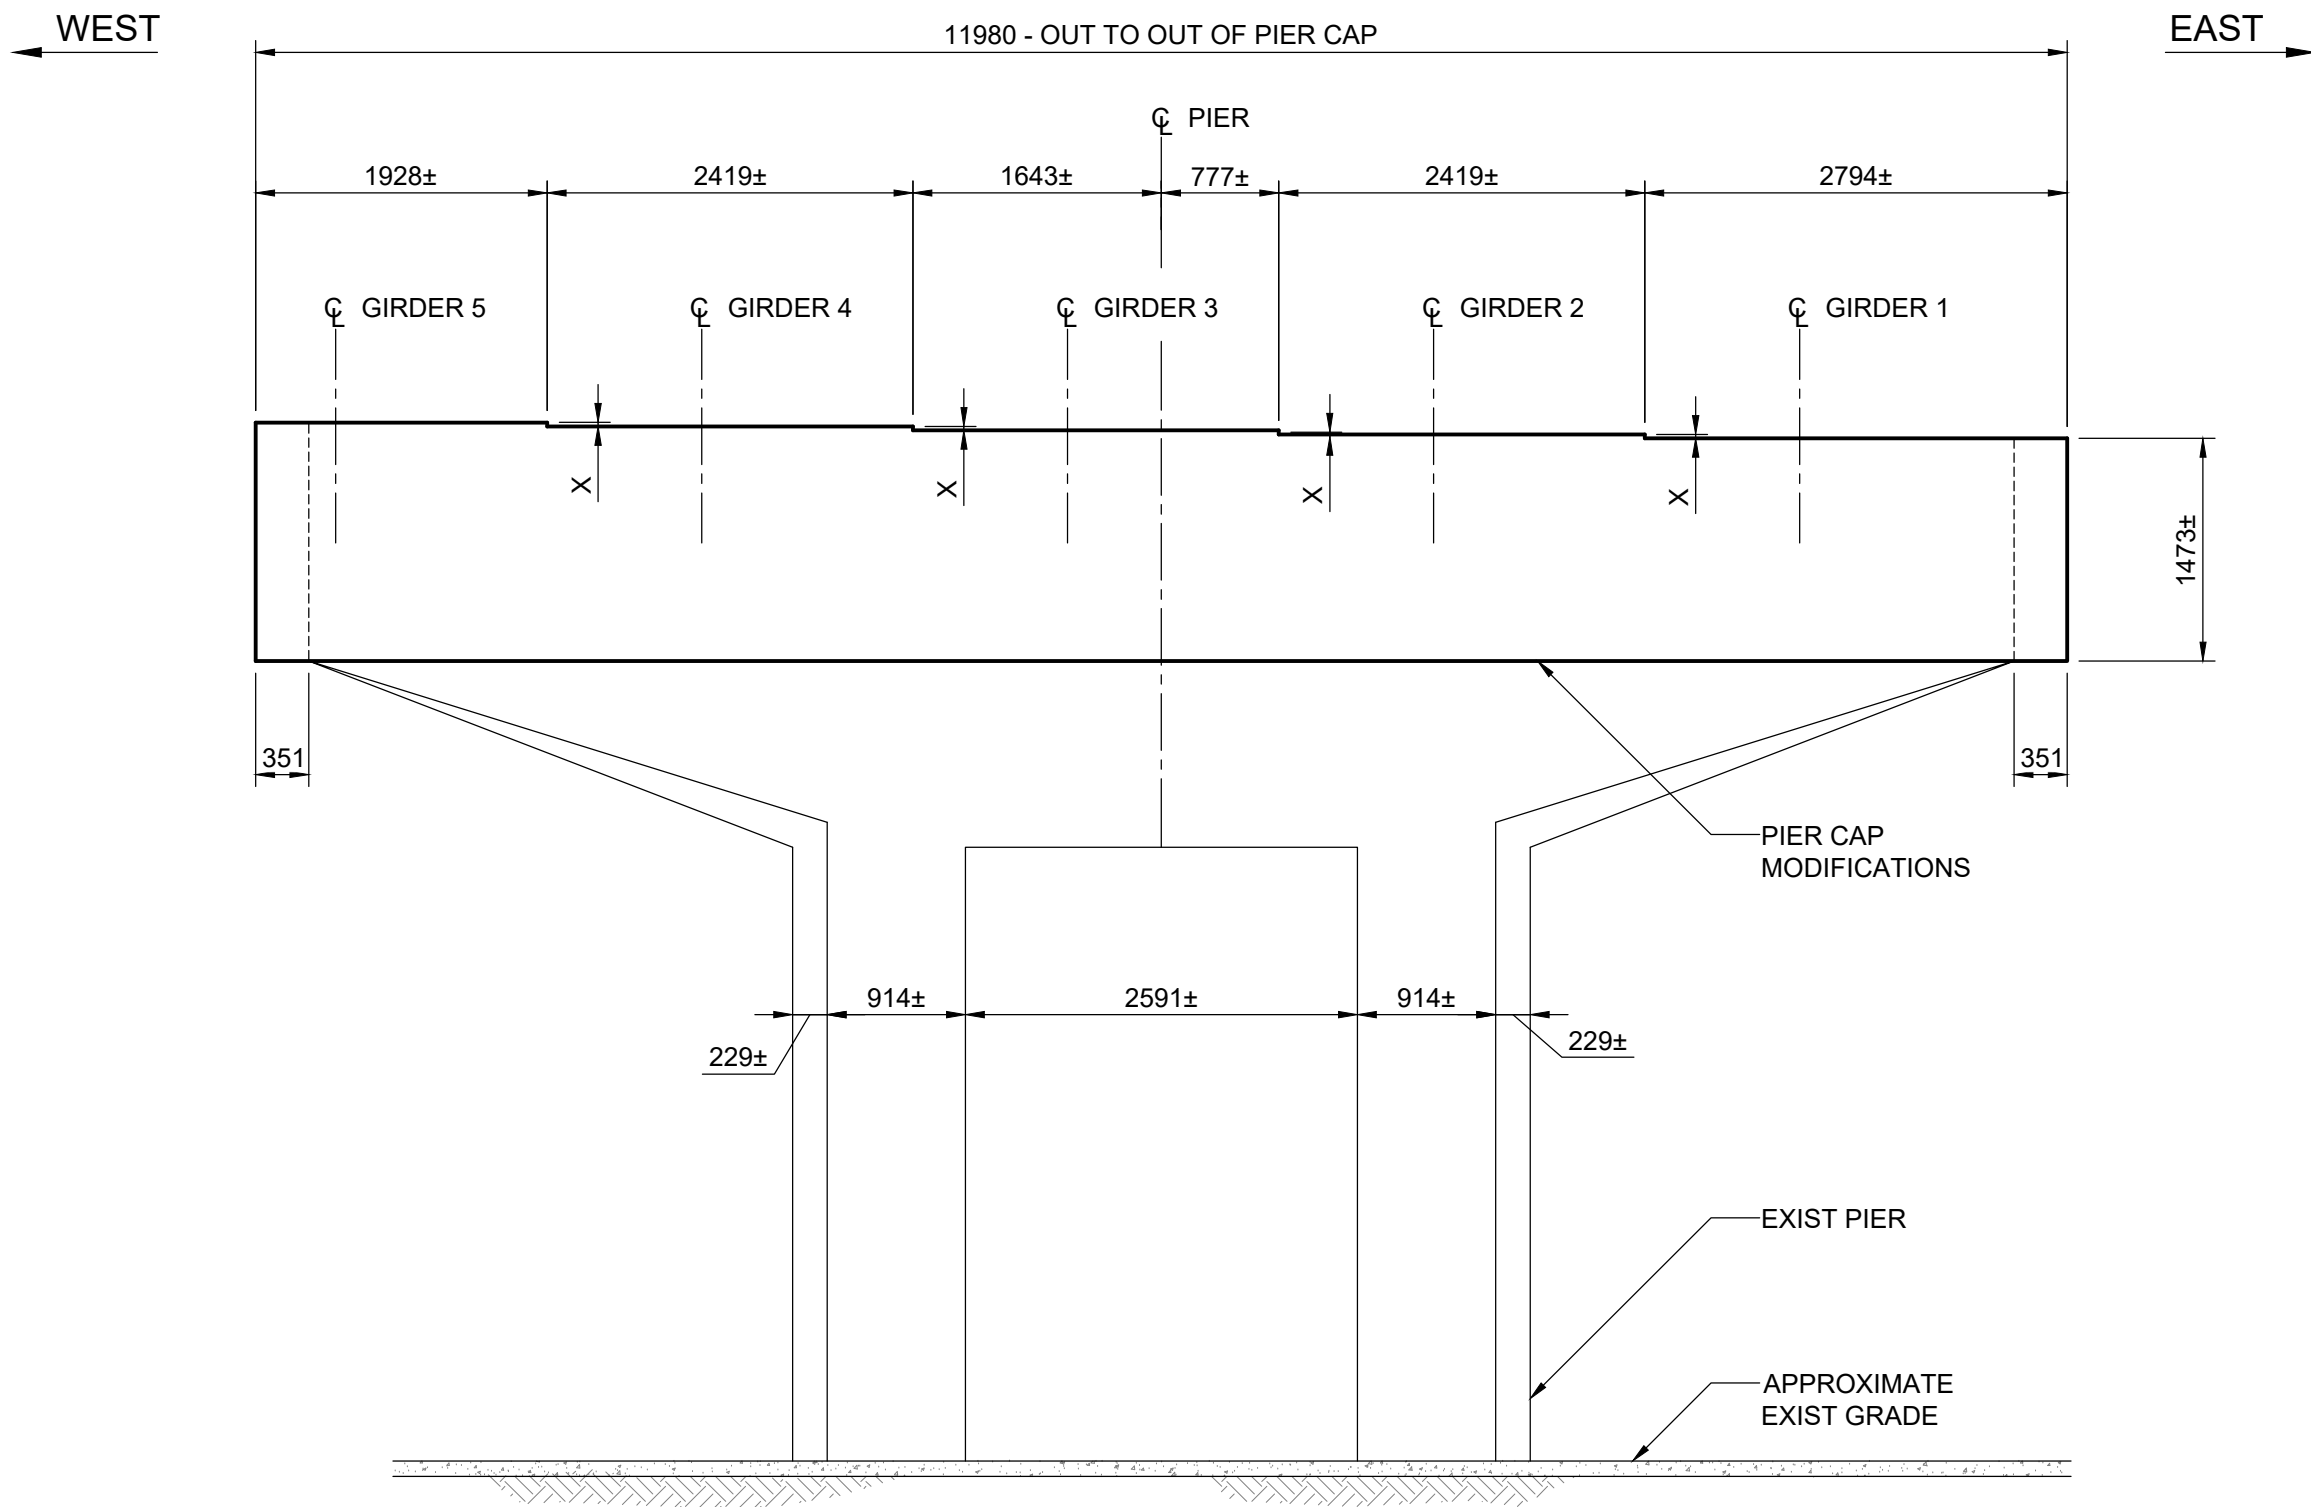

2 PIER FRONT SOUTH ELEVATION

1 : 50


- EXISTING PIER N-1 SHOWN, N-2 N-3 AND N-4 SIMILAR
- FOR SURFACE MOUNTED UNDERBRIDGE LIGHTING FIXTURES AND CONDUITS, REFER TO ELECTRICAL DRAWINGS FOR DETAILS

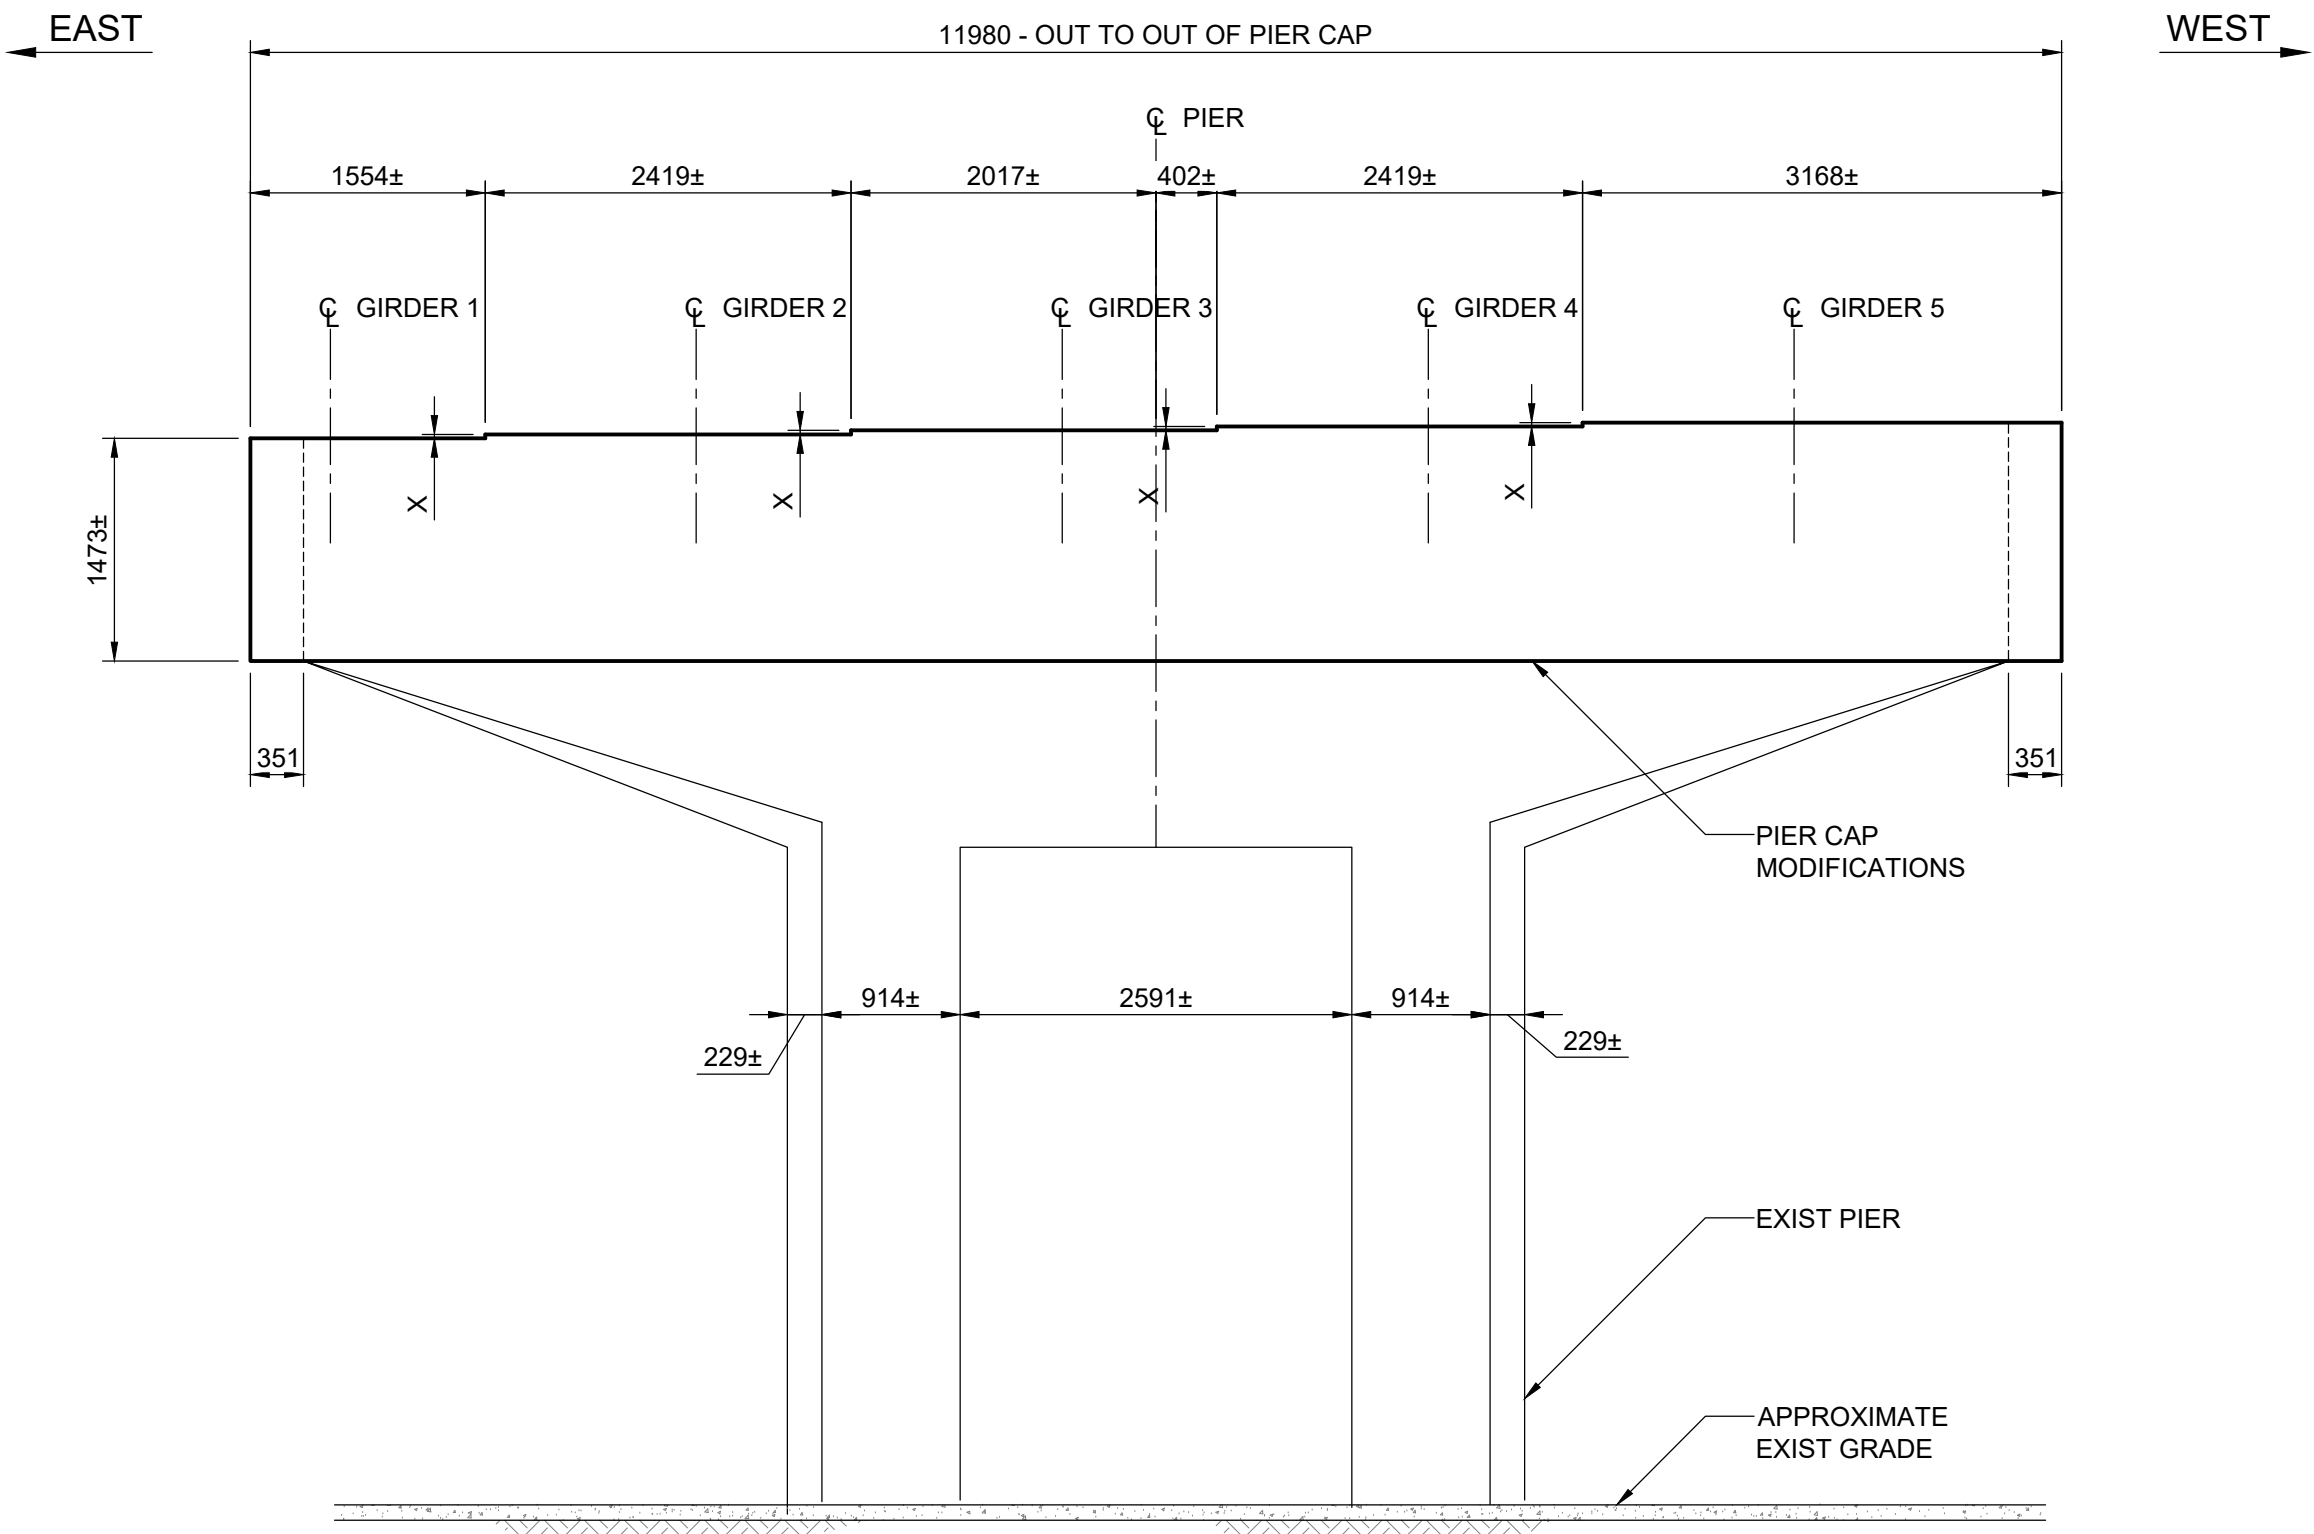

3 PIER FRONT NORTH ELEVATION

1 : 50

- EXISTING PIER N-1 SHOWN, N-2 N-3 AND N-4 SIMILAR
- FOR SURFACE MOUNTED UNDERBRIDGE LIGHTING FIXTURES AND CONDUITS, REFER TO ELECTRICAL DRAWINGS FOR DETAILS

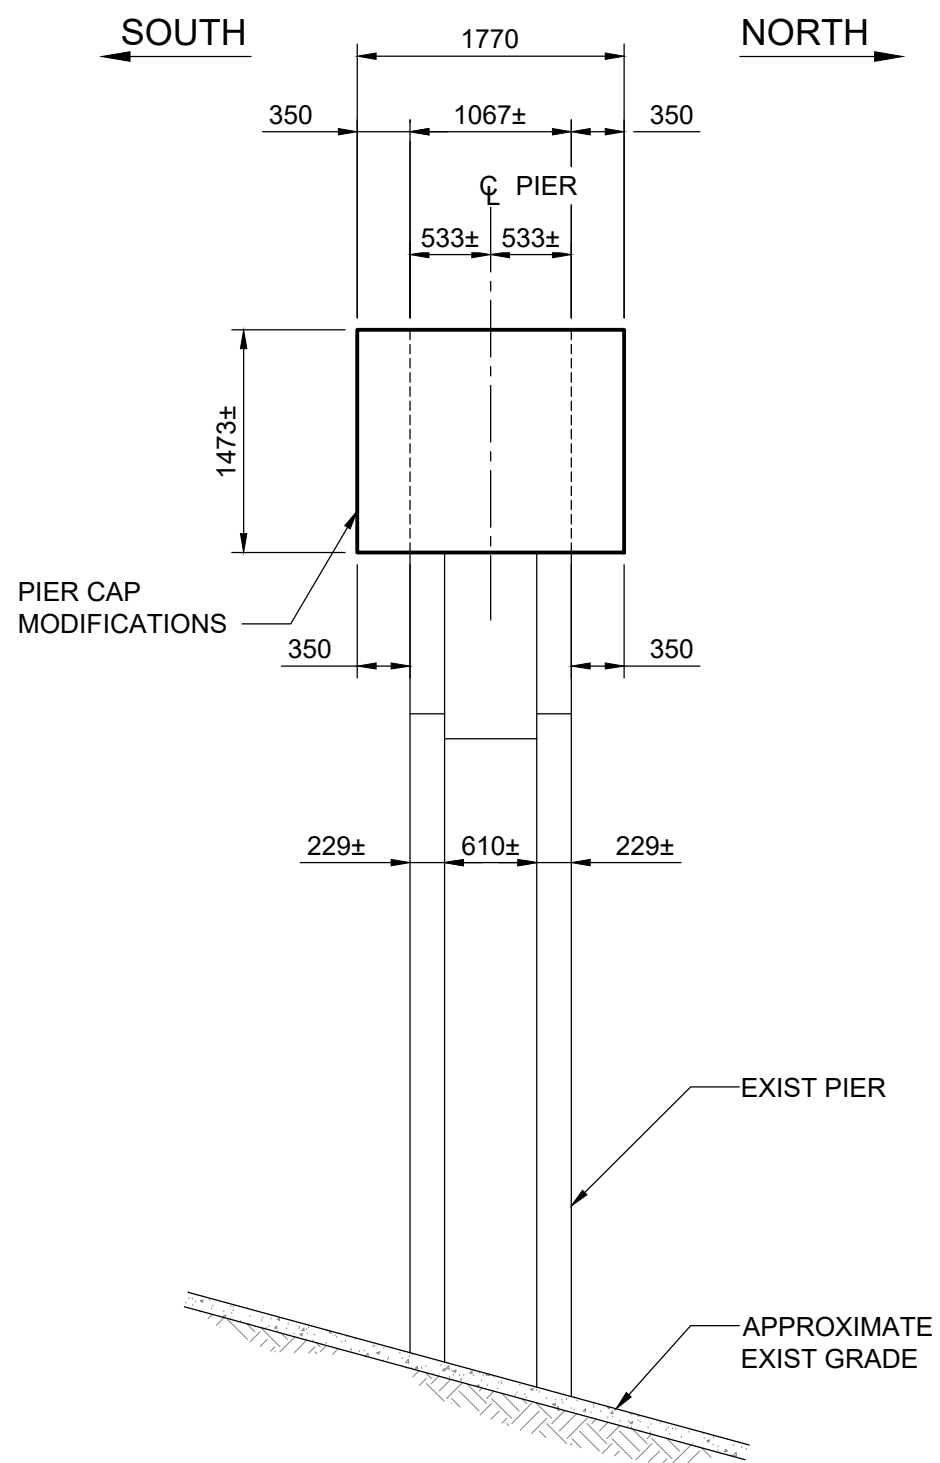

5 EAST END ELEVATION


1 : 50

- FOR SURFACE MOUNTED UNDERBRIDGE LIGHTING FIXTURES AND CONDUITS, REFER TO ELECTRICAL DRAWINGS FOR DETAILS

NOTE:

- ALL EXPOSED EDGES TO BE CHAMFERED 20mm UNLESS NOTED OTHERWISE.
- ROUGHEN EXISTING PIER SURFACES IN CONTACT WITH PIER CAP MODIFICATIONS AS PER ICRI GUIDELINE No. 310.2R (MEDIUM SCARIFICATION) TO 6mm AMPLITUDE.



B.M. ELEV.				<div>TETRA TECH</div>		CONSULTANT DRAWING NO. 704-INF-MBI03007.01-DWG-S2213
				DESIGNED BY RL	REVIEWED BY SA	
				DRAWN BY EV	APPROVED BY KA	
				SCALE: AS NOTED	ACCEPTED BY DATE	
0	ISSUED FOR TENDER	25.08.07	SA	CAM WARD, P.ENG. 25.08.07		
NO.	REVISIONS	DATE	BY	DATE	25.08.07	



LAGIMODIERE TWIN OVERPASSES OVER CPKC KEEWATIN REHABILITATION AND RELATED WORKS		CITY DRAWING NUMBER B123-25-2213
NORTHBOUND STRUCTURE PIER N-1, N-2, N-3, N-4 - CONCRETE DETAILS		SHEET 13 OF 48 2213