JNIT HEATER SCHEDULE								
TAG	SERVICE	HEATING CAPACITY	FLOW RATE	VOLTS/Ø	TYPE			
UH-F65	MAIN FLOOR	10 kW	330 L/s (700 CFM)	575/3	STELPRO ASHU 1063			
UH-F66	DRY WELL	10 kW	330 L/s (700 CFM)	575/3	STELPRO ASHU 1063			
NOTES:								

1) UNIT HEATERS SUPPLIED WITH THERMOSTAT, SETPOINT 15°C ADJUSTABLE.

DUCT	H	EATING	SCH	HEDULE	<u> </u>		Г	_
			_	HEATING		\ \\\\\\\\\\\\\\\\\\\\\\\\\\\\\\\\\\\\		

CAPACITY TYPE SERVICE FLOW RATE | VOLTS/Ø | CONTROL PRICE DF CF00V 575/3 0-10V HCE-F63 SUPPLY DUCT 39 kW

2) SETPOINT 15°C ADJUSTABLE.

3) INTEGRAL WITH AIR PROVING SWITCH

FV-F603 EXHAUST AIR

1) SUPPLY AIR TEMPERATURE SENSOR AT BOTTOM OF DUCT.

DAMPER	SCHEDULE						
TAG	SERVICE	AIRFLOW	SIZE	FAIL POSITION	VOLTAGE	CONTROL SIGNAL	TYPE
FV-F601	OUTDOOR AIR	560 L/s (1185 CFM)	813x610 mm (32x24 in)	OPEN	24VAC	0-10V	TAMCO 9000 THERMALLY INSULATED DAMPER
FV-F602	RETURN AIR	560 L/S (1185 CFM)	813x610 mm (32x24 in)	CLOSED	24VAC	0-10V	TAMCO 1000 AIR-FOIL CONTROL DAMPER
FV-F603	FXHALIST AIR	560 L/S (1185	1625x510 mm (64x20 in)	OPFN	24VAC	0-107	TAMCO 9000 THERMALLY

1625x510 mm (64x20 in) OPEN

24VAC 0-10V

INSULATED DAMPER

1)DAMPERS CONTROLLED WITH BELIMO NFBUP-S ELECTRIC ACTUATORS, 24VAC, 0-10V, 90 IN-LB.

2)DAMPER POSITION CONTROLLED BY OCCUPANCY SWITCH. UNOCCUPIED: OA & EA DAMPERS 25% OPEN, RA DAMPER 75% OPEN. OCCUPIED: OA & EA DAMPERS 100% OPEN, RA DAMPER 0% OPEN.

DIFFUSER SCHEDULE SERVICE TYPE AIRFLOW SIZE 1100 L/s (2330 CFM) 864x356 mm (34x14 in) PRICE 34X14 520D/F/S/A/B12 GRD-F641 MAIN FLOOR MAIN FLOOR 1100 L/s (2330 CFM) 864x356 mm (34x14 in) PRICE 34X14 520D/F/S/A/B12 GRD-F642

1) ADJUST BLADES TO DISTRIBUTE AIR TOWARDS MOTORS

2) C/W RG-10W RETURN GRILLE

TAG	SERVICE	MENT SCHE	FLOW RATE	VOLTS/Ø	TYPE
		CAPACITY			>
AC-F64	MAIN FLOOR	44 kW (12.5 TON)	2195 L/s (4650 CFM)	575/3	BARD W150APQ0ZEPXX3X W/LC6000

SUPPLY FAN SCHEDULE						
TAG	SERVICE	FLOW RATE	VOLTS/Ø	TYPE		
SF-F62	DRY WELL	560 L/s (1185 CFM)	575/3	GREENHECK SQ-130		
NOTES:						

1) C/W WITH MATCHING AAF SUREPLEAT SIDE ACCESS FILTER HOUSING AND PERFECTPLEAT 100mm (4") HC M8 FILTERS

FIRE EXTINGUISHER SCHEDULE RATING/ WEIGHT NOTES 2A, 5BC, 4.5 KG (10 LB) DRY CHEMICAL NEW

SUMP F	PUMP SC	HEDULE								
TAG	SERVICE	POWER	VOLTS/Ø	TYPE						
P-F05	SUMP PIT	1 HP	120/1	SUBMERSIBLE,	MIN.	250	L/MIN.	@	8M	HEA
NOTEO										

1) PROVIDE BACKFLOW VALVES BEFORE DISCHARGE TO WET WELL. 2) MOTOR TO INCLUDE AUTOMATIC THERMAL AND OVERLOAD PROTECTION.

CONSTRUCTION NOTES:

INSTALL NEW WATER METER (SUPPLIED BY CLIENT) AND MAIN SHUTOFF VALVE.


2 SUPPLY AND INSTALL NEW BACKFLOW PREVENTER C/W RELIEF VALVE AIR GAP DRAIN TO SUMP PIT.

SUPPLY AND INSTALL NEW PUMP PACKING LINES, C/W 3 VALVES, SOLENOID VALVE, HAND VALVE FOR FLOW CONTROL, FLOW SWITCH.

(4) SUPPLY AND INSTALL NEW HOSE BIBB.

EXISTING SHUTOFF TO REMAIN IN OPEN POSITION: CONTROL STEM TO REMAIN.

SUPPLY AND INSTALL NEW SUMP PUMP, PIPING, VALVES, 6 AND CHECK VALVES, CONNECT TO EXISTING DISCHARGE TO WET WELL WET WELL.

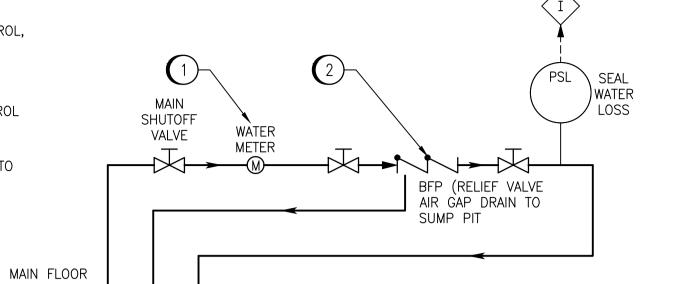


GENERAL NOTES

1. COORDINATE WITH DIVISION 26 WHERE EQUIPMENT

2. ALL EQUIPMENT, DEVICES AND CABLING ARE NEW.

→ HOSE BIBB

THAT REQUIRES NEW ELECTRICAL IS INSTALLED.

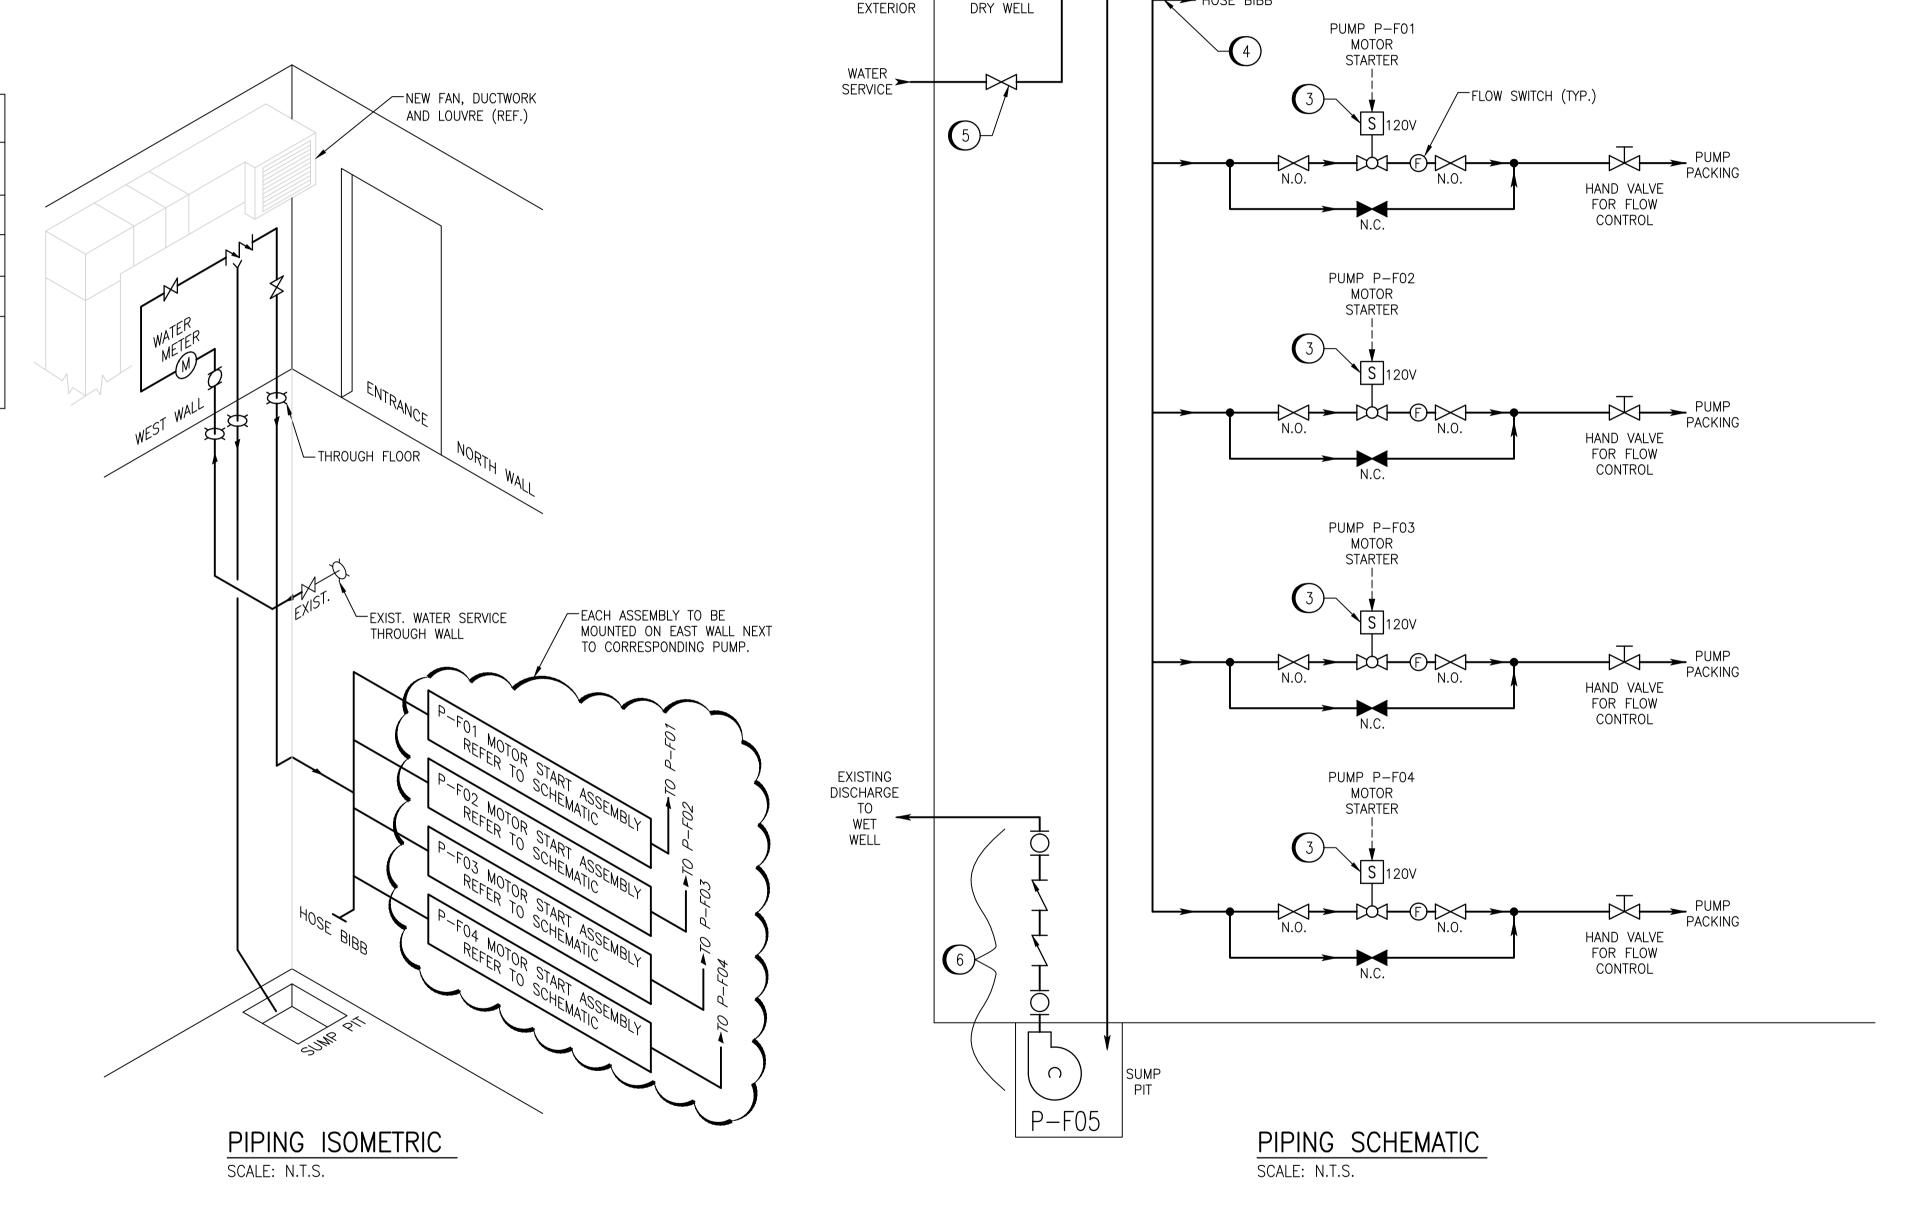



NO. REVISIONS

				_	*))	SNC-LAVALIN INC. 148 Nature Park Way	ENGINEER'S SEAL
					SNC+LAVALIN	Winnipeg, MB, Canada R3P 0X7 204-786-8080	
					DESIGNED BY: N. LEE	CHECKED BY: S. NORSWORTHY	
					DRAWN BY: D. CALVERLEY	APPROVED BY: B. CLEVEN	
					scale: AS NOTED	ISSUED FOR CONSTRUCTION BY: K. ZUREK	
01	ISSUED FOR ADDENDUM 01	2023-03-27	NL	BC	DATE: 2022/08/17	DATE: 2023/02/17	
00	ISSUED FOR CONSTRUCTION TENDER 167–2023	2023-03-02	NI	BC	OONICHI TANT. NO .	·	-

DATE DESIGN CHECK

THE CITY OF WINNIPEG WATER AND WASTE DEPARTMENT

BANNATYNE FLOOD PUMPING STATION 2023 UPGRADES MECHANICAL SCHEDULES

NEW WORK CITY DRAWING NUMBER SHEET REV. SIZE 1-0118F-M0003 001 | 01 | A1

1-0118F-M0002 -0118F-P0001

MECHANICAL PLAN LAYOUT, MAIN FLOOR AND EXTERIOR, NEW WORK PROCESS AND INSTRUMENTATION DIAGRAM HVAC SYSTEM DRAWING NUMBER REFERENCE DRAWINGS

1-0118F-M0003.dwg