

**NOTES** 

BELT DRIVE UPBLAST ROOF EXHAUST

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C/W MOUNTING BRACKET

GAS FIRED UNIT HEATER SCHEDULE								
			GAS HI	EATING	FAN SELECTION			
TAG	MANUFACTURER	MODEL	INPUT	OUTPUT	AIRFLOW	MOTOR		
			BTUH	BTUH	CFM	HP		
UH-01	REZNOR	UEAS-310	305,000	277,550	4,283	0.5	ŀ	
UH-02	REZNOR	UEAS-310	305,000	277,550	4,283	0.5	ŀ	
UH-03	REZNOR	UEAS-310	305,000	277,550	4,283	0.5	ŀ	
UH-04	REZNOR	UEAS-310	305,000	277,550	4,283	0.5	H	
UH-05	REZNOR	UEAS-310	305,000	277,550	4,283	0.5		
UH-06	REZNOR	UEAS-310	305,000	277,550	4,283	0.5		

NEDERMAN N24 CENTRIFUGAL 600 4.5 C/W MOUNTING BRACKET NOTES - ROOF EXHAUST FAN SHALL COME WITH ROOF CURB AND BACKDRAFT DAMPER.

0.6

0.6

4.5

4.5

4.5

4.5

4.5

MOTOR

HP

BHP

1.5

1.5

**FAN SCHEDULE** 

AIRFLOW

CFM

5600

5600

600

600

600

600

600

TYPE

CENTRIFUGAL

CENTRIFUGAL

CENTRIFUGAL

CENTRIFUGAL

CENTRIFUGAL

CENTRIFUGAL

CENTRIFUGAL

COOK PRODUCT IS AN APPROVED EQUAL TO SPECIFIED GREENHECK ROOF EXHAUST FAN. ackslash Monoxivent product is an approved equal to the specified nederman hose reel exhaust fan,eta

**MANUFACTURER** 

GREENHECK

GREENHECK

NEDERMAN

NEDERMAN

NEDERMAN

NEDERMAN

NEDERMAN

F-6

F-8

MODEL

CUBE-220-20

CUBE-220-20

N24

N24

N24

N24

N24

	GAS FIRED UNIT HEATER SCHEDULE								
TAG	MANUFACTURER		GAS HEATING		FAN SELECTION				
		MODEL	INPUT	OUTPUT	AIRFLOW	MOTOR	REMARKS		
			BTUH	BTUH	CFM	HP			
UH-01	REZNOR	UEAS-310	305,000	277,550	4,283	0.5	HIGH EFFICIENCY		
UH-02	REZNOR	UEAS-310	305,000	277,550	4,283	0.5	HIGH EFFICIENCY		
UH-03	REZNOR	UEAS-310	305,000	277,550	4,283	0.5	HIGH EFFICIENCY		
UH-04	REZNOR	UEAS-310	305,000	277,550	4,283	0.5	HIGH EFFICIENCY		
UH-05	REZNOR	UEAS-310	305,000	277,550	4,283	0.5	HIGH EFFICIENCY		
UH-06	REZNOR	UEAS-310	305,000	277,550	4,283	0.5	HIGH EFFICIENCY		

THERMOSTAT C/W GUARD COMBUSTION AIR/VENT KIT INCLUDING CONCENTRIC ADAPTER NOTES:

PACIFIC AVE THESE DRAWINGS SHALL NOT BE SCALED.

THE CONTRACTOR SHALL VISIT THE SITE AND SATISFY ONESELF ALL DIMENSIONS, DATUM, AND DETAILED INFORMATION SHOWN ARE CORRECT.

THE CONTRACTOR IS TO REVIEW AND COORDINATE ALL MECHANICAL AND ELECTRICAL DRAWINGS FOR ADDITIONAL OPENINGS THROUGH FLOORS, WALLS, AND CEILINGS FOR DUCT, PIPE & ELECTRICAL RISERS AND ALL OPENINGS NOT SHOWN ON DRAWINGS.

> ALL OPENINGS THROUGH FIRE ASSEMBLIES ARE TO BE FIRE STOPPED AND SEALED WITH ULC APPROVED FIRE STOPPING TO MAINTAIN THE INTEGRITY OF THE FIRE SEPARATION, AND PROVIDE A SMOKE-TIGHT BARRIER.

ALL PRODUCTS AND MATERIALS TO BE USED AND INSTALLED SHALL CONFORM WITH MANUFACTURER'S SPECIFICATIONS & APPLICABLE

THE CONTRACTOR SHALL BE RESPONSIBLE TO PATCH AND MAKE GOOD ALL EXISTING CONSTRUCTION AFFECTED BY THE REMOVAL OF ALL ITEMS FORMING THE PART OF THE RENOVATION WORK.

THE MECHANICAL CONTRACTOR SHALL ARRANGE WITH MANITOBA HYDRO GAS DIVISION FOR REVISION TO GAS SERVICE INCLUDING PRESSURE REGULATOR. THE COST OF THIS SERVICE SHALL BE INCLUDED IN THE COST OF THIS CONTRACT.

VEHICLE EXHAUST FAN CONTROL:

INDIVIDUAL EXHAUST FAN ON EXHAUST REELS SHALL BE ACTIVATED BY SPRING RECOIL REEL ACTIVATING THE DEDICATED VEHICLE EXHAUST FAN. AN ON/OFF SWITCH C/W FAN CONTACTOR AND A 24V TRANSFORMER. STARTS AND STOPS THE VEHICLE EXHAUST FAN WHEN THE HOSE COILS/UNCOILS.

THE EXISTING ROOF IS STILL UNDER WARRANTY, ALL ROOF WORK SHALL SUB-CONTRACTED TO OAKWOOD ROOF AND SHEET METAL CO.

ASBESTOS IS KNOWN TO BE PRESENT IN EXTERIOR WALL. ABATEMEN TO PROCEED START OF DEMOLITION. ASBESTOS MAYBE PRESENT IN OTHER AREAS. IF ASBESTOS OR ANY HAZARDOUS MATERIAL IS FOUND: > STOP WORK AND CONTACT CITY OF WINNIPEG, CENTRAL CONTROL, PH: 204-986-2351.

MECHANICAL DRAWING LIST				
SHEET No:	SHEET TITLE			
M1	MECHANICAL DEMOLITION, KEY PLAN, MECHANICAL LEGEND AND SCHEDULES			
M2	MECHANICAL RENOVATION			
M3	MECHANICAL SPECIFICATIONS & DETAILS			

1	ISSUED FOR ADDENDUM	EAG	JUNE 1 2021
0	ISSUED FOR CONSTRUCTION		JUNE ( 2021
No.	REVISION/DESCRIPTION	BY	DATE
SEAL			

DRAWN		CHECKED	ATW	DESIGNED	AT VV	APPROVED	۸۱۱
DATE	2020.06.12	USER APPROVAL					



PLANNING, PROPERTY AND DEVELOPMENT DEPARTMENT MUNICIPAL ACCOMMODATIONS DIVISION 3-65 GARRY STREET, R3C 4K4 PROJECT

THE CITY OF WINNIPEG


VEHICLE REPAIR SHOP VENTILATION SYSTEM UPGRADE

195 TECUMSEH ST. SHEET TITLE

> PARTIAL MAIN FLOOR PLAN MECHANICAL DEMOLITION

M1-R1 2018-120 AS SHOWN

DRAWING SHEET SIZE: A1 (841mm x 594mm) PLOT 1:1

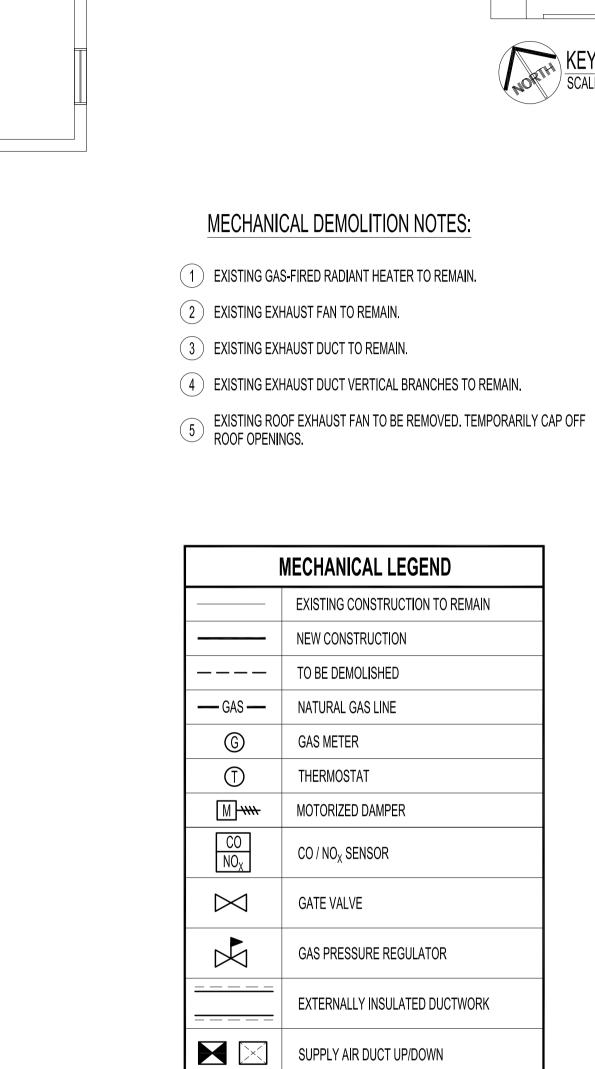

AREA OF WORK

MECHANICAL LEGEND

NEW CONSTRUCTION

TO BE DEMOLISHED

NATURAL GAS LINE

**GAS METER** 

**THERMOSTAT** 

MOTORIZED DAMPER

CO / NO<sub>X</sub> SENSOR

GAS PRESSURE REGULATOR

SUPPLY AIR DUCT UP/DOWN

RETURN AIR DUCT UP/DOWN

**EQUIPMENT DESIGNATION** 

EXTERNALLY INSULATED DUCTWORK

GATE VALVE

EXISTING CONSTRUCTION TO REMAIN

KEY PLAN SCALE: N.T.S.