

KEY NOTES



- EXISTING PANELS C AND D ON UPPER LEVEL REMOVE PANELS AND REPLACE WITH JUNCTION BOXES. RELOCATE PANELS TO LOWER LEVEL AS SHOWN ON RENOVATION PLAN.
- EXISTING PANEL ON LOWER LEVEL.
- 600/480V TRANSFORMER TO BE REPLACED. SECONDARY OUTPUT BELOW RATED DUE TO DEGRADED WINDING INSULATION.
- DEMOLISH REMOTE HEAD. EXTEND RACEWAY AND WIRES TO SUIT EMERGENCY LIGHTING RENOVATION LAYOUT.
- CANUCK LOCKER ROOM BRANCH PANEL.
- REMOVE "EXIT STYLE" EXIT SIGN AND REPLACE WITH RUNNING MAN EXIT SIGN.

DEMOLITION GENERAL NOTES


- WHERE BRANCH CIRCUIT BREAKERS ARE REMOVED, PROVIDE FILLER PLATES FOR BREAKER SPACES.
- CIRCUIT BREAKERS SHALL MATCH EXISTING. CONFIRM SHORT CIRCUIT RATING AND TYPE ON SITE, PRIOR TO FINALIZING PRICING.
- UTILIZE SPARE/FREED UP CIRCUITS FROM DEMOLITION AS REQUIRED TO ACCOMMODATE THE ADDITIONAL CIRCUITING REQUIREMENTS IN THE RENOVATION.
- PROVIDE NEW TYPEWRITTEN PANEL DIRECTORIES TO ACCOMMODATE UPDATED CIRCUITING. NEW BREAKERS IN DISTRIBUTION PANELS SHALL BE LABELLED USING LAMACODS.
- DEMOLISH ALL UNUSED WIRING IN CEILINGS, RESUPPORT REMAINING.
- AS INDICATED IN THE GENERAL NOTES, DEMOLITION NOTES, AND KEYNOTES IN THIS DRAWING PACKAGE, UNLESS NOTED OTHERWISE, THE TERM "DEMOLISH" SHALL INCLUDE THE COMPLETE REMOVAL OF THE EXISTING ITEM IDENTIFIED, C/W ASSOCIATED WIRING, CONDUIT AND JUNCTION BOXES BACK TO LAST REMAINING DEVICE OR SOURCE. CIRCUITS FREED UP FROM DEMOLISHED ELECTRICAL, SHALL BECOME SPARE. REFER TO THE RENOVATION DRAWING KEY NOTES FOR FURTHER REQUIREMENTS.
- AS INDICATED IN THE GENERAL NOTES, DEMOLITION NOTES, AND KEYNOTES IN THIS DRAWING PACKAGE, UNLESS NOTED OTHERWISE, THE TERM "REMOVE & REPLACE" SHALL INCLUDE THE COMPLETE REMOVAL & REPLACEMENT OF THE EXISTING ITEM IDENTIFIED IN ITS CURRENT LOCATION, WITH A NEW ITEM, UTILIZING THE EXISTING OUTLET BOX AND WIRING. REFER TO THE RENOVATION DRAWING KEY NOTES FOR FURTHER REQUIREMENTS.
- AS INDICATED IN THE GENERAL NOTES, DEMOLITION NOTES, AND KEY NOTES, UNLESS NOTED OTHERWISE, THE TERM "RELOCATE" SHALL INCLUDE THE COMPLETE RELOCATION OF THE EXISTING ITEM IDENTIFIED IN ITS CURRENT LOCATION ON THE DEMOLITION DRAWINGS, TO THE NEW LOCATION AS INDICATED ON THE RENOVATION DRAWINGS, INCLUDE ALL LABOUR AND MATERIALS TO REROUTE/EXTEND/FREED THE EXISTING CIRCUITRY AS REQUIRED TO ACCOMMODATE THE RELOCATION. REFER TO THE RENOVATION DRAWING KEY NOTES FOR FURTHER REQUIREMENTS.
- SITE CONFIRM ANY ELECTRICAL WITHIN AREAS OF RENOVATION REQUIRING RELOCATION TO ACCOMMODATE THE RENOVATION.
- PROVIDE WIRE AND CONDUIT AS REQUIRED FOR CONTINUITY OF ANY FEEDERS OR BRANCH CIRCUITS ORIGINATING OUTSIDE THE DEMOLITION AREA THAT SERVES ANY ELECTRICAL EQUIPMENT OR DEVICES TO REMAIN AFTER DEMOLITION. MODIFY OR REPLACE AS REQUIRED.
- PROVIDE CONDUIT AND/OR COMMUNICATIONS/DATA WIRING AS NECESSARY FOR CONTINUITY OF ANY COMMUNICATIONS/DATA SYSTEMS ORIGINATING OUTSIDE THE DEMOLITION AREA THAT SERVES ANY COMMUNICATIONS/DATA EQUIPMENT OR DEVICES TO REMAIN AFTER DEMOLITION. MODIFY OR REPLACE AS REQUIRED.
- PROVIDE BLANK COVERPLATES OVER ALL EXISTING UNUSED OPENINGS.
- DEMOLISH ALL ELECTRICAL DEVICES IN WALLS, FLOORS OR CEILINGS TO BE DEMOLISHED. WALLS TO BE DEMOLISHED ARE SHOWN DASHED. CONFIRM EXTENT OF DEMOLITION WITH ALL DISCIPLINE DRAWINGS. DISCONNECT AND REMOVE ASSOCIATED SWITCHES, DISCONNECTS, WIRING AND CONDUIT. REROUTE/EXTEND/REFEED EXISTING ELECTRICAL AS REQUIRED TO MAINTAIN EXISTING SYSTEMS NOT INDICATED TO BE REMOVED.
- RELOCATE EXISTING LIGHT SWITCHES AS REQUIRED TO ACCOMMODATE NEW DOOR CONFIGURATIONS.
- DEMOLISH ALL REDUNDANT DEVICES AND EQUIPMENT INCLUDING ASSOCIATED SWITCHES, DISCONNECTS, WIRING AND CONDUIT.
- DRAWING RECORDS OF THE EXISTING FLOOR PLANS HAVE BEEN COMPILED FROM THE INFORMATION SUBMITTED BY THE OWNER AND FROM SITE OBSERVATIONS AS NOTED BY THE CONSULTANT. THE ACCURACY OF THESE DRAWING RECORDS IS LIMITED TO THE EXTENT OF KNOWN CONSTRUCTION INFORMATION.
- ALL EXISTING VOICE/DATA DEVICES, CCTV CAMERAS, OVERHEAD PAGING SPEAKERS AND INTRUSION DETECTION DEVICES TO BE DEMOLISHED BACK TO SOURCE UNLESS SPECIFIED OTHERWISE. TURN OVER ALL EXISTING CCTV CAMERAS AND HEAD END EQUIPMENT TO OWNER.

REFEREE ROOM - DEMO 2
1" = 10'-0" EC1.1-R1

ARENA COMBINED ELECTRICAL - DEMO 1
1" = 10'-0" EC1.1-R1

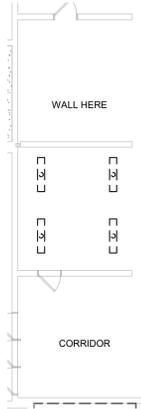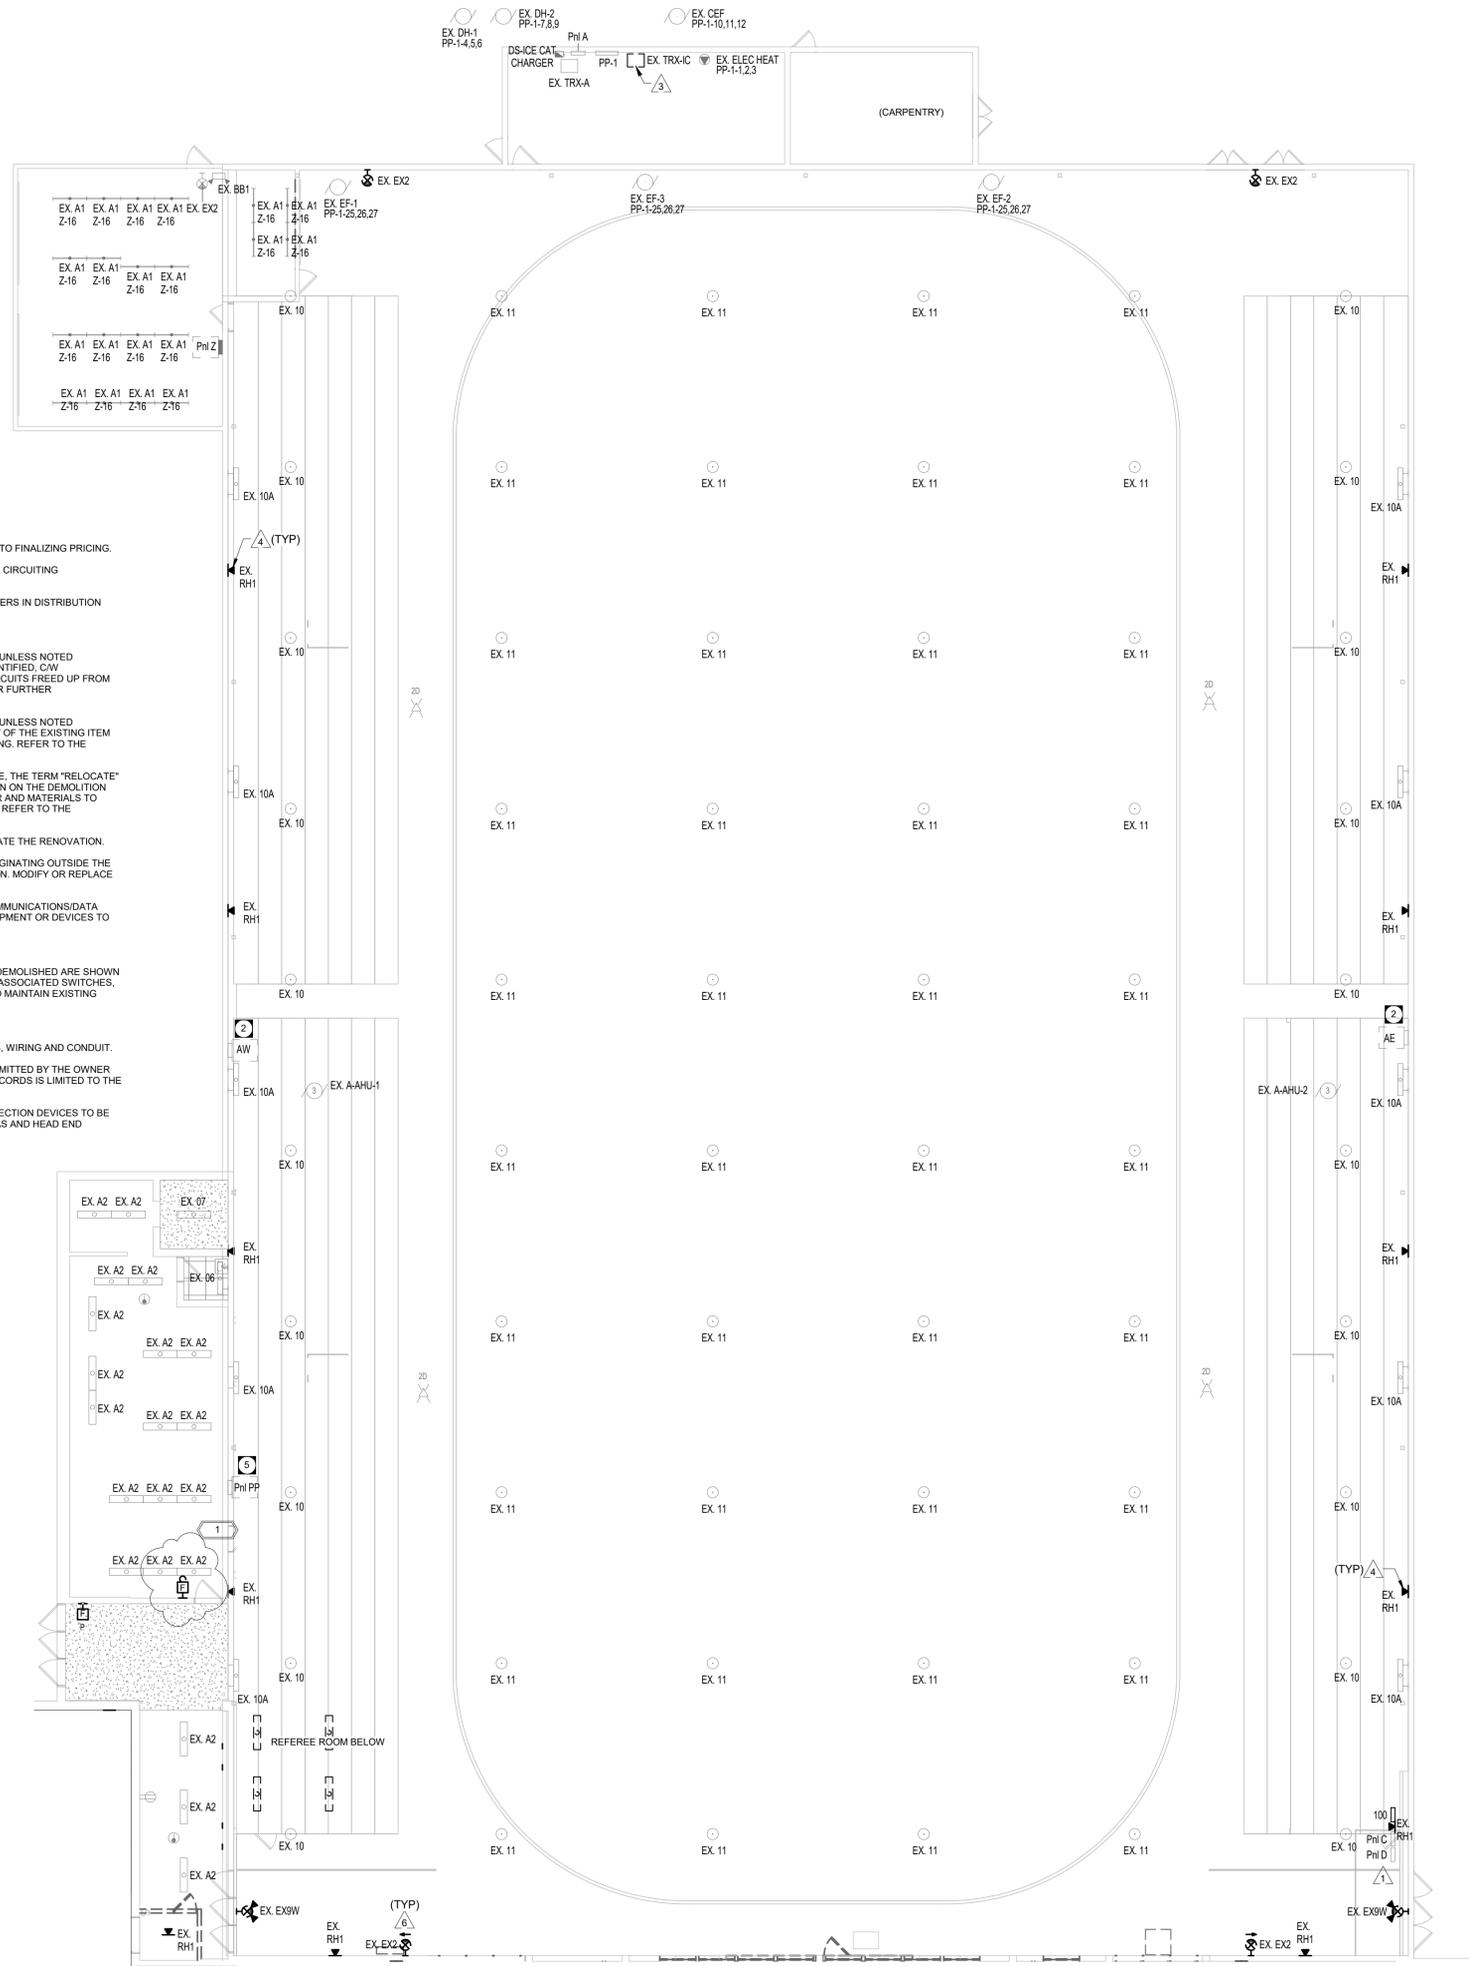

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Project
ST. JAMES CIVIC CENTRE

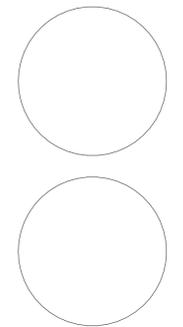Drawing
ARENA ELECTRICAL PLAN - DEMOLITION

Drawn By:	Review By:
JA	MP
Scale:	Tender No:
As indicated	1176-2019
Date:	11/06/19
Sheet:	