
GENERAL NOTES:

- 1. CONNECTIONS TO PERIMETER GROUNDING CONDUCTORS SHALL BE 'C' CRIMP PRESSURE CONNECTION OR EXOTHERMIC WELD. ALL COMPRESSION CONNECTIONS SHALL UTILIZE PENETROX JOINT COMPOUND.
- 2. ALL GROUNDING CONDUCTOR SHALL BE STRANDED, SOFT DRAWN COPPER, UNLESS NOTED OTHERWISE.
- 3. FOR CONDUIT RUNS CONFINED WITHIN THE ELECTRICAL ROOM, EMT MAY BE USED. FOR ANY CONDUITS EXITING THE ELECTRICAL ROOM, RIGID THREADED ALUMINUM CONDUIT SHALL BE USED.
- 4. ALL WIRES/CABLES SHALL BE RUN IN CONDUIT. SIZE CONDUITS IN ACCORDANCE WITH THE CEC.
- 5. NOT ALL BOND CONNECTIONS ARE SHOWN AS A MINIMUM PERFORM BONDING IN ACCORDANCE WITH CEC.

CONSTRUCTION NOTES:

- PROVIDE LAMACOID TAG ON WALL, ABOVE THE GROUND CONDUCTORS INDICATING "SYSTEM GROUND" AS APPLICABLE.
- 2 PROVIDE GROUND CONNECTION FROM SYSTEM GROUND TO TRANSFORMER XO TERMINAL.
- PROVIDE GROUND CONNECTION TO POWER FACTOR CORRECTION UNIT, PFC-M713, AS PER MANUFACTURER'S REQUIREMENTS.
- PROVIDE A GROUND CONNECTION TO THE TRANSFORMER ENCLOSURE SEPARATE FROM XO TERMINAL CONNECTION.

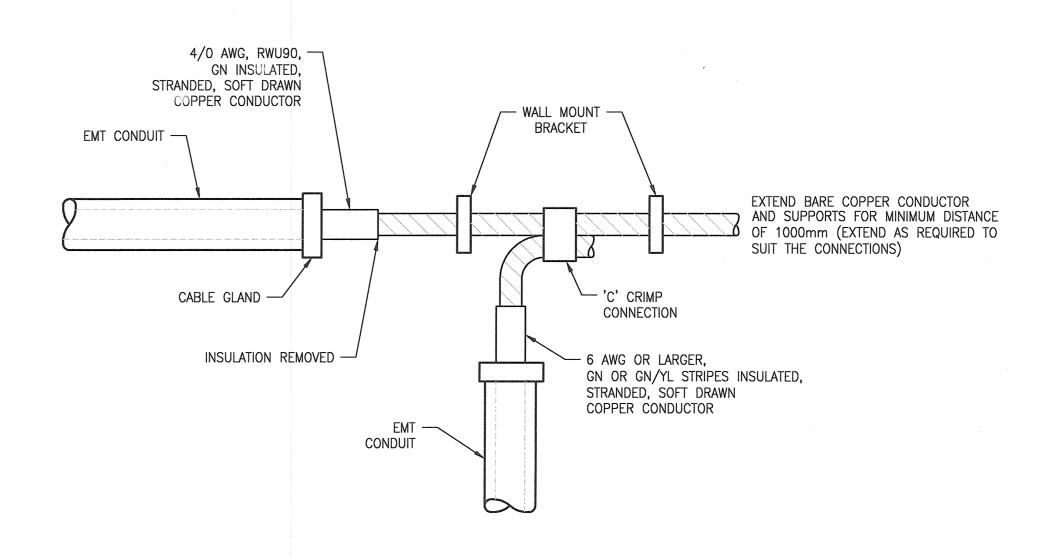

B GROUND CONNECTION POINT DETAIL (TYP).

EQUIPMENT GROUNDING CONNECTION

SCALE: NTS

-	

Certificate of Authorization
SNC-Lavalin Inc.
No. 4489

				1	•))	SNC-LAVALIN INC. 148 Nature Park Way Winnipeg, MB, Canada R3P 0X7	ENGINEER'S SEAL
					SNC·LAVALIN	204-786-8080	ANTHE OF
					DESIGNED BY: S. JUGANAS	CHECKED BY: K. SAPIAK	13/ /
	*				DRAWN BY: S. JUGANAS	APPROVED BY: D. BECKER	ELHO Men
					SCALE: NTS	ISSUED FOR CONSTRUCTION BY: A. WEISS	Mem 346
		200			DATE: 2019/04/23	DATE: 2019/10/18	
00	ISSUED FOR TENDER AND CONSTRUCTION	2019/10/18	SLJ	KS	CONSULTANT NO.:		OC1.18
NO.	REVISIONS	DATE	DESIGN	CHECK			2019

Winnipeg

Winnipeg THE CITY OF WINNIPEG WATER AND WASTE DEPARTMENT

MCPHILLIPS WATER PUMPING STATION
ELECTRICAL AND HVAC UPGRADES, MCC REPLACEMENT
ELECTRICAL GROUNDING
RISER DIAGRAM

 CITY DRAWING NUMBER
 SHEET
 REV.
 SIZE

 1-0640M-E0044
 001
 00
 A1

10M-E0044-001-00.d

72/4ENG/47ELE\DD - General DWG\01 McPhillips\1-0640M-E0044-001-00.dwg

-0640M-E0045

-0640M-E0036

1-0640M-E0034

-0640M-E0032

-0640M-E0002

DRAWING NUMBER

GROUNDING LAYOUT MAIN FLOOR

ELECTRICAL SINGLE LINE DIAGRAM, MCC-M730E

ELECTRICAL SINGLE LINE DIAGRAM, MCC-M720

ELECTRICAL SINGLE LINE DIAGRAM, MCC-M710

ELECTRICAL SINGLE LINE DIAGRAM, 4160V DISTRIBUTION

REFERENCE DRAWINGS