



NOTES:

- 1. STATION IN CENTRE OF McGREGOR RIGHT-OF-WAY UNLESS OTHERWISE NOTED.
- BASELINE IS CENTRELINE OF McGREGOR RIGHT-OF-WAY. 3. NORTH PROPERTY LINE OF SELKIRK AVENUE IS STA 1+00.0
- 4. ALL MEASUREMENTS TO BACK OF CURB.
- 5. ALL EXISTING TREES TO BE PROTECTED AND MAINTAINED THROUGHOUT CONSTRUCTION.
- 6. ALL BUS STOPS WITHIN LIMITS OF CONSTRUCTION TO BE TEMPORARILY RELOCATED BY OTHERS DURING WORKS.
- 7. HAND OR SOFT DIG METHODS REQUIRED OVER ALL UTILITIES AT INTERVALS DETERMINED BY THE ENGINEER TO DETERMINE DEPTH OF COVER.
- 8. NO WORKS, INCLUDING CONCRETE CUTTING OR BREAKING, TO BE UNDERTAKEN NEAR GAS LINES UNTIL DEPTH OF COVER IS DETERMINED AND A MB HYDRO
- SAFETY WATCH IS ON SITE. 9. ANY GAS MAINS OR SERVICES EXPOSED IN THE EXCAVATION AREA TO BE ROCK WRAPPED IN ACCORDANCE WITH MB HYDRO STANDARDS PRIOR TO WORK
- PROCEEDING ON SITE. 10. NO VIBRATORY COMPACTION PERMITTED WITHIN 1M OF GAS MAINS.
- 11. INSTALL MODIFIED BARRIER CURB AT ALL INTERSECTION RADII, ALLEY RADII, AND BULLNOSES.
- 12. CONSTRUCT NEW MONOLITHIC CURB RAMP (10mm HEIGHT INTEGRAL) 13. REMOVE EXISTING SD-024 CATCHBASIN AND INSTALL NEW BARRIER CURB AND
- GUTTER INLET FRAME (AP-008) AND AND INLET COVER (AP-008) AND 250 LEAD @ 2% MINIMUM GRADE.
- 14. TRANSVERSE JOINTS SPACED AT 5.0 INTERVALS UNLESS OTHERWISE NOTED. 15. ADJUST ALL WATER VALVES, MANHOLES AND CATCH BASINS TO GRADE.
- 16. INSTALL DETECTABLE WARNING SURFACE TILE (SD-229AB) IN ALL CORNERS OF
- STREET INTERSECTIONS.
- 17. INSTALL 6.0-1500 SUBDRAIN (SD-245) BOTH SIDES OF ALL PROPOSED
- CATCHBASINS. 18. REMOVE EXISTING SIGN
- 19. INSTALL MOUNTING SLEEVE AT LOCATIONS INDICATED
- 20. REMOVE EXISTING CATCHBASIN AND ABANDON LEAD
- 21. APPROACH GRADES SHOWN REPRESENT AVERAGE SLOPES. CROSSFALL ACROSS SIDEWALK TRAVEL PATH TO BE 5% OR LESS.
- 22. INSULATE ALL WATERMAINS AND SERVICES UNDER NEW PAVEMENT IN ACCORDANCE WITH SD-018.

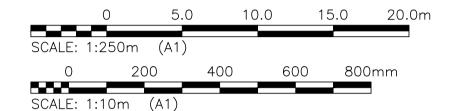

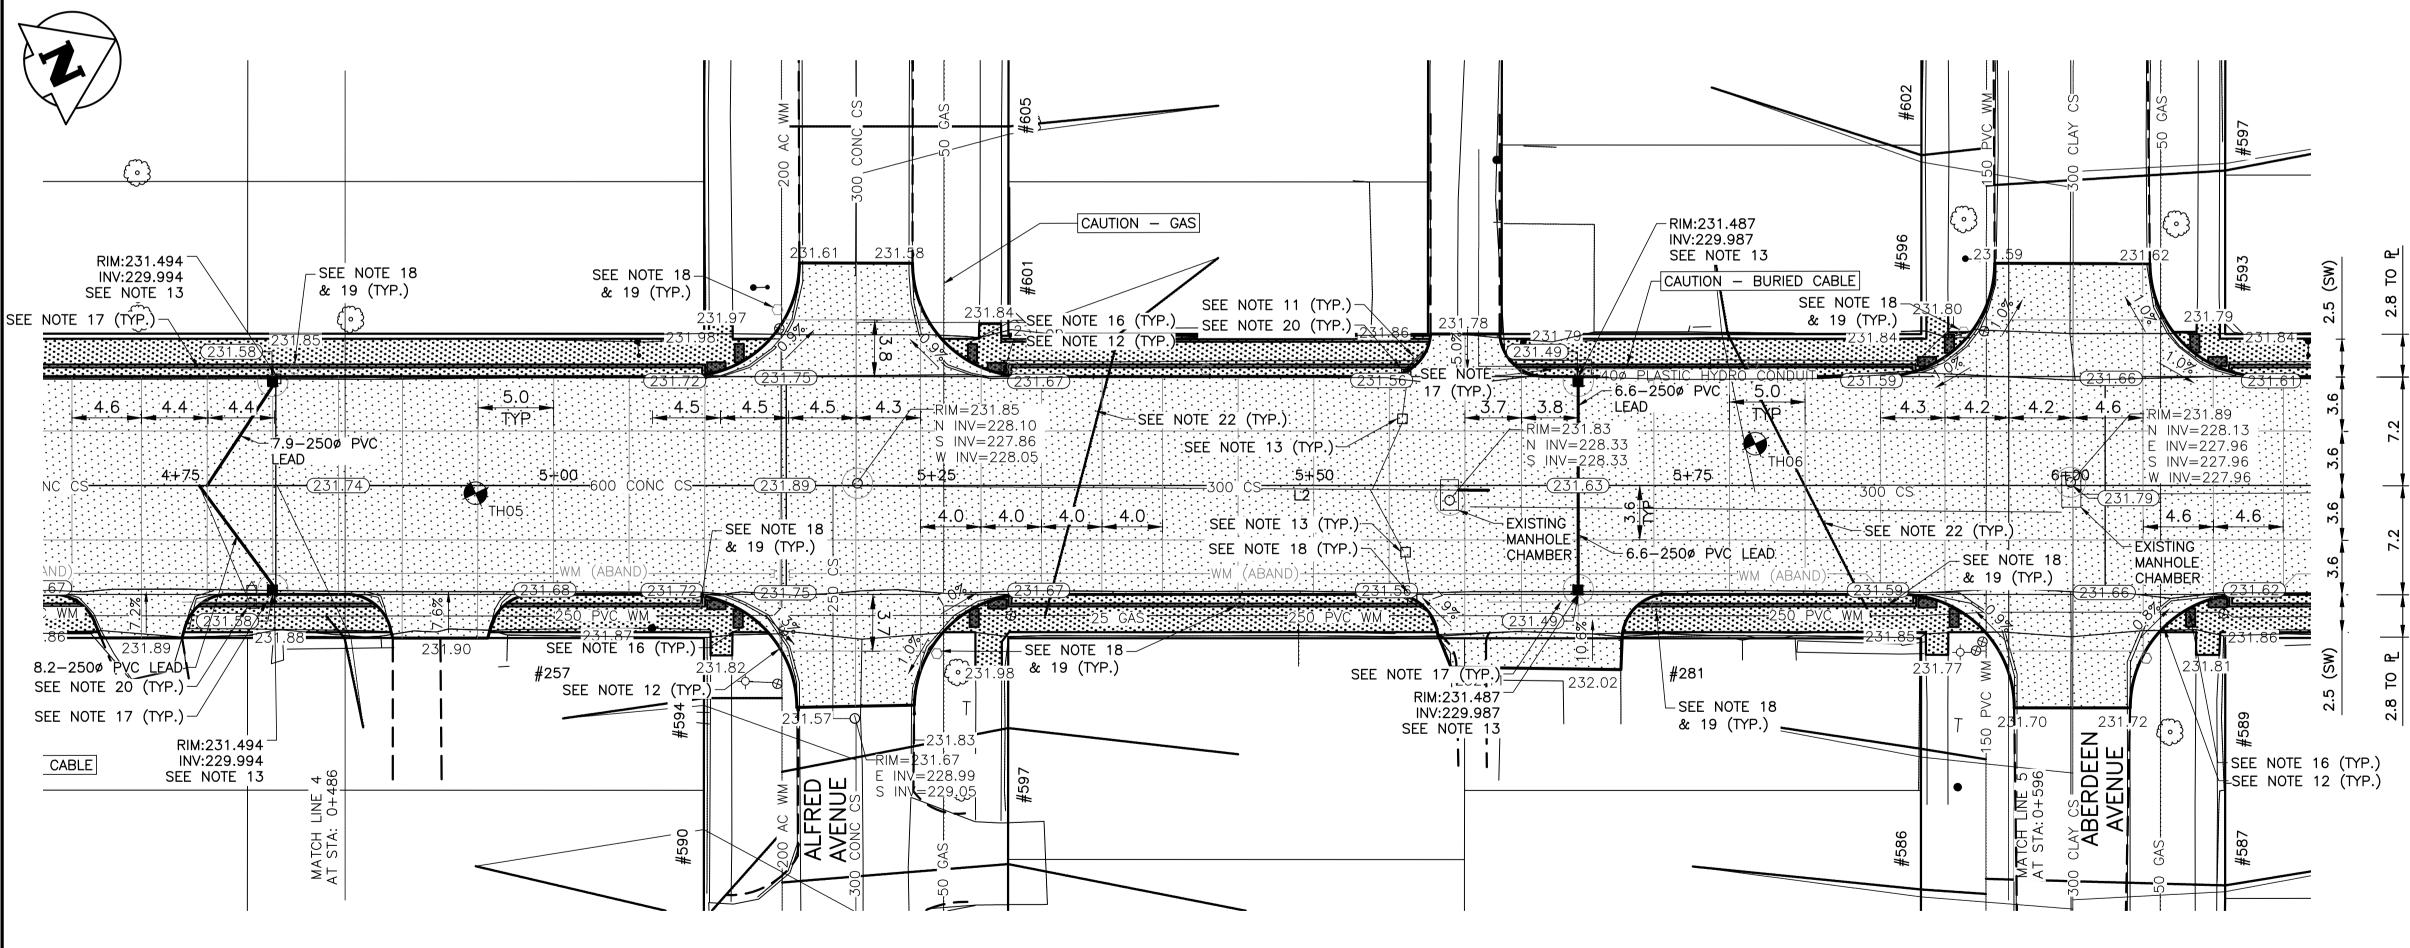

LOCATIONS OF UNDERGROUND STRUCTURES AS SHOWN ARE BASED ON THE BEST INFORMATION AVAILABLE. BUT NO GUARANTEE IS GIVEN THAT ALL EXISTING UTILITIES ARE SHOWN OR THAT THE GIVEN LOCATIONS ARE EXACT. CONFIRMATION OF THE EXISTENCE AND EXACT LOCATION OF ALL SERVICES MUST BE OBTAINED FROM INDIVIDUAL UTILITIES BEFORE PROCEEDING WITH CONSTRUCTION.

PROPERTY LIMITS DELINEATION

DELINEATION OF PROPERTY LIMITS AS SHOWN ON THIS DWG DOES NOT REPRESENT A "LEGAL SURVEY". KGS GROUP MAKES NO REPRESENTATION OR WARRANTY AS TO THE ACCURACY OF PROPERTY LIMITS DELINEATED ON THIS DWG, NOR ON THE DIMENSIONAL ACCURACY OF DWG FEATURES RELATIVE TO THOSE PROPERTY LIMITS.

WARNING

NOTIFY THE GAS COMPANY OF THE PROPOSED LOCATION OF EXCAVATION.

TAKE PRECAUTION TO AVOID DAMAGE TO GAS COMPANY INSTALLATIONS.

SEE PROVINCIAL REGULATION 210/72 FOR DETAILS.

METRIC

WHOLE NUMBERS INDICATE MILLIMETRES DECIMALIZED NUMBERS INDICATE METRES



No. 245

THE	CITY	OF	WINNIPE
PUBLIC	WORKS	S DEF	PARTMENT

ENGINEERING DIVISION 2018 REGIONAL STREET PACKAGE

McGREGOR STREET

13 COMPUTER FILE NAME 17-0107-022_CALL.DWG CITY DRAWING NUMBER P-3491-06

OF

	300 LDS	LAND DRAINAGE SEWER	300 LDS	_						
	<u>250 WWS</u>	WASTE WATER SEWER	<u>250 WWS</u>	*	TEST HOLE					П
		GAS		\dashv	GUY WIRE					
		HYDRO		•••	LIGHT STANDARD					
	· ·	M.T.S.			BACK OF CURB					
	1 <u>50_WM</u>	WATERMAIN	<u>150 WM</u>		CONCRETE		\times \times	€ PROFILE	×	CC
	-	HYDRANT	+		ASPHALT		·	WEST GUTTER	·	N
`	\otimes	VALVE	⊗		SIDEWALK		⊙——⊙	EAST GUTTER	00	
	0	MANHOLE	•		PROPERTY LINE		\Diamond	N/W LANE P		SH AV
		CATCH BASIN		+	SURVEY BAR	+	\bigcirc	S/E MEDIAN PL		TH,
	∇	CURB INLET	▼	0	GEODETIC BENCHMARK		70	PARKING/DRIVEWAY		СО
	•	POLES T-MTS H-HYDRO	-	231.334	ELEVATION	(32.231)	77777	WINDOW/DOOR SILL		LO OB
	EXISTING	LEGEND-PLAN	PROPOSED	EXISTING	LEGEND-PLAN	PROPOSED	EXISTING	LEGEND-PROFILE	PROPOSED	BE

LOCATION APPROVED B.M. KGS_BASE COORDINATE SYSTEM: CGVD28 ENGINEER'S SEAL **KGS** UNDERGROUND STRUCTURES GROUP CONSULTING ENGINEERS SUPV. U/G STRUCTURES COMMITTÉE DESIGNED CHECKED LOCATION OF UNDERGROUND STRUCTURES AS APPROVED SHOWN ARE BASED ON THE BEST INFORMATION DRAWN AVAILABLE BUT NO GUARANTEE IS GIVEN THAT ALL EXISTING UTILITIES ARE SHOWN OR THAT THE GIVEN LOCATIONS ARE EXACT. HOR. SCALE: 1:250 RELEASED FOR CONFIRMATION OF EXISTENCE AND EXACT CONSTRUCTION: CONSULTANT DRAWING NO. LOCATION OF ALL SERVICES MUST BE VERTICAL: 1:10 A ISSUED FOR TENDER OBTAINED FROM THE INDIVIDUAL UTILITIES 18/04/05 C105 BEFORE PROCEEDING WITH CONSTRUCTION. NO. REVISIONS DATE BY DATE 2018/01/08

PLAN AND PROFILE 04+80.00 TO 05+90.00