


1 REMOVALS PLAN
RP-L2 Scale: 1:100

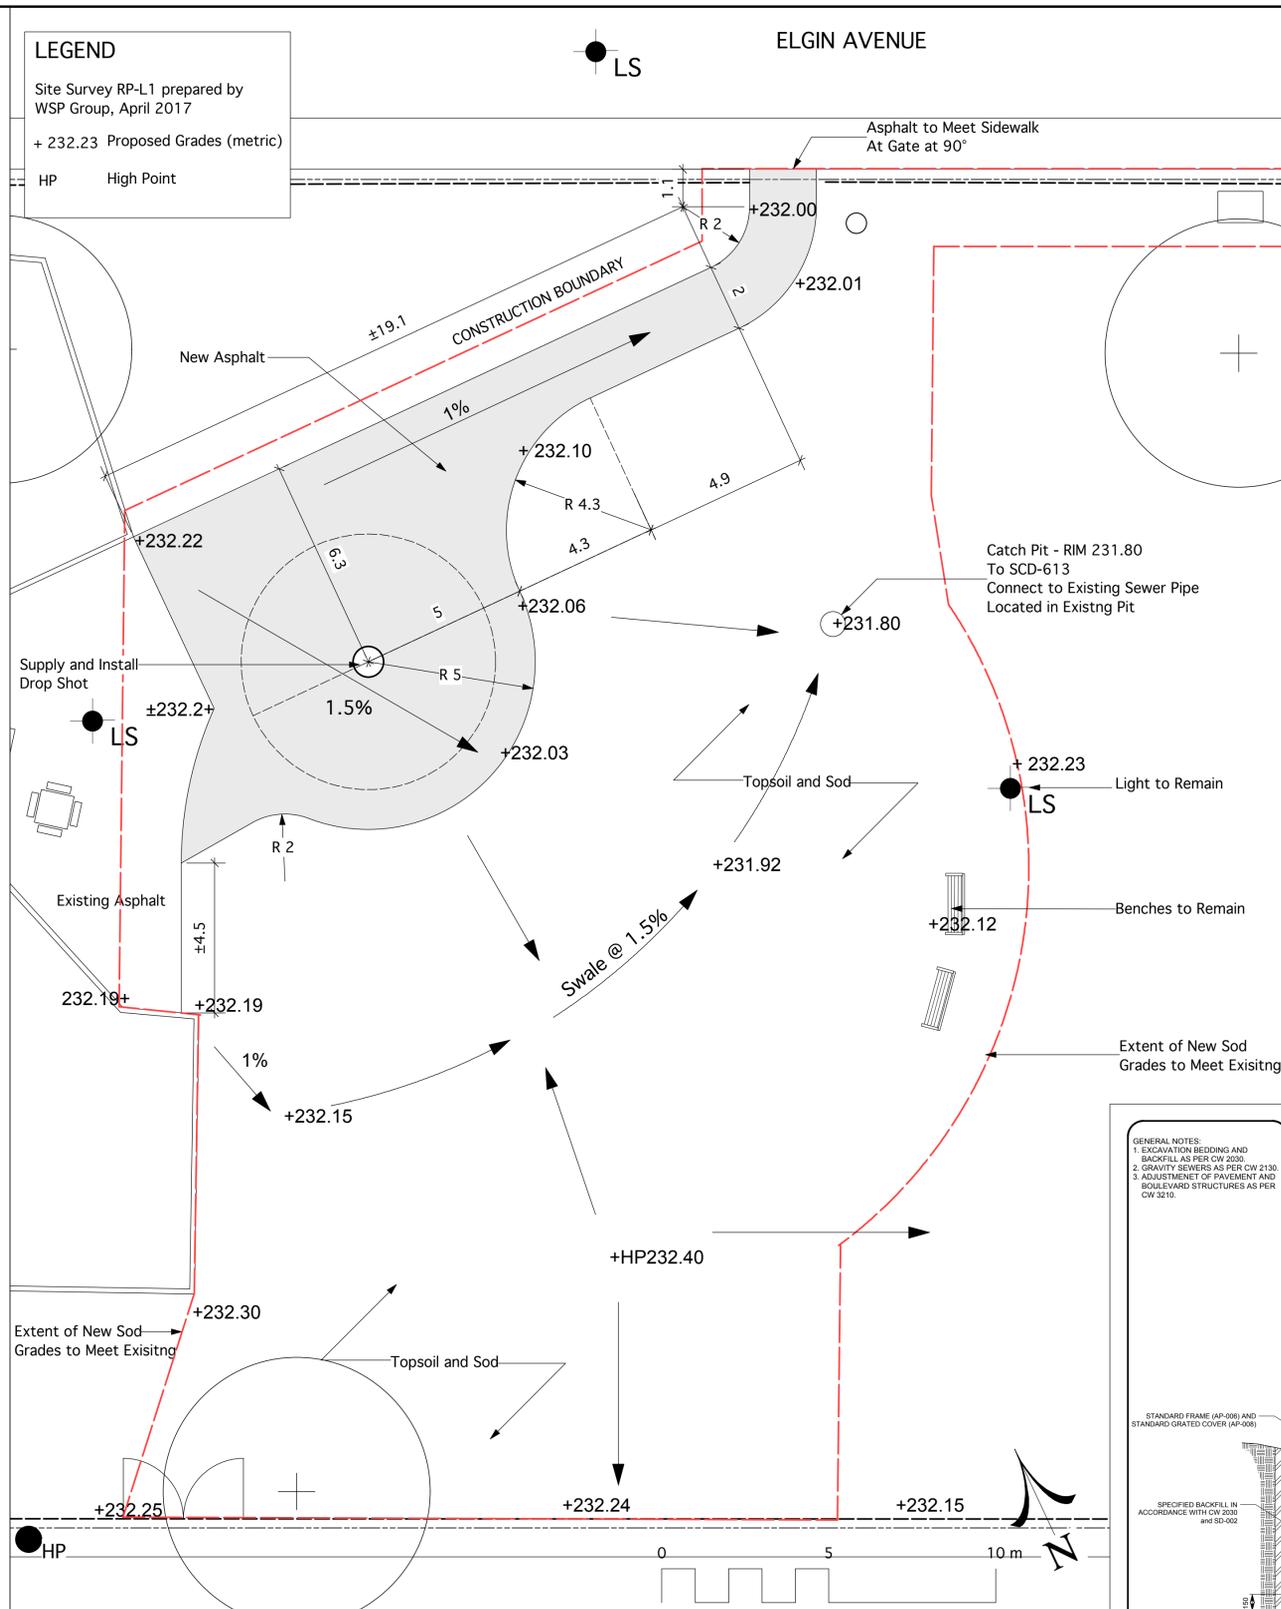

2 DEVELOPMENT AND GRADING PLAN
RP-L2 Scale: 1:100

LEGEND
Site Survey RP-L1 prepared by WSP Group, April 2017
+ 232.23 Proposed Grades (metric)
HP High Point

STANDARD PRE-CAST CONCRETE CATCH PIT

GENERAL NOTES:
1. EXCAVATION BEDDINGS AND BACKFILL AS PER CW 2030.
2. GRAVITY SEWERS AS PER CW 2130.
3. ADJUSTMENT OF PAVEMENT AND BOULEVARD STRUCTURES AS PER CW 3210.

CATCH PITS CAN ONLY BE USED WHEN CONNECTED TO A CATCH BASIN BEFORE CONNECTING TO THE MAIN LAND DRAINAGE SEWER LINE.

USE PRE-FORMED BITUMINOUS GASKET BETWEEN REDUCER AND BARREL SECTION.

PLAN

SECTION A - A

FINISHED GRADE
MAXIMUM 2-750 DIA. PRECAST CONCRETE ADJUSTING RINGS OR 1 LAYER CONCRETE BRICK AND GROUT AS REQUIRED TO MAKE WATER TIGHT
900 DIA. X 750 DIA. PRECAST CONCRETE REDUCER
900 DIA. X 480 PRECAST CONCRETE CATCH PIT SECTION TO ASTM C 478 AND C78 CL. II
INITIAL BACKFILL IN ACCORDANCE WITH CW 2030 AND SD-001
MINIMUM 250 DIA. LEAD TO CATCH BASIN
BEDDING IN ACCORDANCE WITH CW 2030 AND SD-001
PRECAST CONCRETE BASE
GROUT TO SLOPE IN FIELD

SCALES: NTS
DATE: October 5, 2016
DRAWN BY: HF

The City of Winnipeg
Planning, Property and Development Department
Unit 15 - 30 Fort Street, Winnipeg, MB, R3C 4X5

Location of underground structures as shown are based on the best information available but no guarantee is given that all existing utilities are shown or that the given locations are exact. Confirmation of existence and exact location of all services must be obtained from the individual utilities before proceeding with construction.
DO NOT SCALE DRAWING - PLOT MAY NOT BE AT 100%



NO.	REVISION / NOTE	DATE	BY
9			
8			
7			
6			
5			
4			
3			
2			
1			

PROJECT
FREIGHT HOUSE SPRAY PAD
AND WADING POOL PROJECTS
ROOSEVELT PARK
534 ELGIN AVENUE
WINNIPEG, MANITOBA

SCALE: 1:100 METRIC
DATE: AUGUST 1, 2017
DRAWN BY: LLW CHECKED BY: DW
PROJECT NO.: 1707

DRAWING TITLE
REMOVALS AND
DEVELOPMENT PLANS
SHEET NO.
RP-L2