	GRILLE AND DIFFUSER SCHEDULE							
TAG	DESCRIPTION	MANUFACTURER	MODEL	REMARKS				
S-1	LINEAR BAR GR I LLE	E.H. PRICE	LBP16B	COLOUR B12, SIZE REFER TO DRAWING				

	FAN SCHEDULE (PROVIDED BY GENERAL CONTRACTOR)								
TAG	MANUFACTURER	MODEL	AIR FLOW cfm @ 0.0"	AIR FLOW cfm @ 0.3"	AMPS	REMARKS			
RH-1	VENT-A-HOOD	900cfm B200 DUAL & B100 SINGLE	900	655	6	10" DUCT, VP562 TRANSITION			
NOTES: 1 INTERLOCK RH-1 WITH MALL1									

	MINI MAKE UP AIR UNIT SCHEDULE							
TAG	MANUFACTURER	MODEL	AIR FLOW cfm	SP in	MAX kW	REMARKS		
MAU-1	THERMOLEC	FER-10-10	300	0.2	10	C/W FILTER AND ELECTRONIC CONTROLLER BUILT I DAMPER, ELECTRONIC TEMPERATURE SENSOR		
NOTES:								

PLUMBING FIXTURE CONNECTION SIZES							
TAG	SANITARY IN	DCW IN	DHW IN	TRAP IN			
SINK	1.5	0.5	0.5	1.5			

SCALE: 1/4"=1'-0"



NOTES:

THESE DRAWINGS SHALL NOT BE SCALED.

PROVIDE A SMOKE-TIGHT BARRIER.

THIS DRAWING IS DIAGRAMMATIC ONLY. CONTRACTOR TO COORDINATE EXACT LOCATIONS OF AND ROUTING ON SITE WITH ALL NEW AND EXISTING SYSTEM.

THE CONTRACTOR SHALL VISIT THE SITE AND SATISFY ONESELF ALL DIMENSIONS, DATUM, AND DETAILED INFORMATION SHOWN ARE CORRECT.

THE CONTRACTOR IS TO REVIEW AND COORDINATE ALL ARCHITECTURAL, MECHANICAL, ELECTRICAL AND STRUCTURAL DRAWINGS FOR ADDITIONAL OPENINGS THROUGH FLOORS, WALLS, AND CEILINGS FOR DUCT, PIPE & ELECTRICAL RISERS AND ALL OPENINGS NOT SHOW

ON DRAWINGS. ALL OPENINGS THROUGH FIRE ASSEMBLIES ARE TO BE FIRE STOPPED AND SEALED WITH ULC APPROVED FIRE STOPPING TO MAINTAIN THE INTEGRITY OF THE FIRE SEPARATION, AND

ALL PRODUCTS AND MATERIALS TO BE USED AND INSTALLED SHALL CONFORM WITH MANUFACTURER'S SPECIFICATIONS & APPLICABLE CODES.

NEW DUCT SHALL BE CONSTRUCTED AS RECOMMENDED BY SMACNA.

THE CONTRACTOR SHALL BE RESPONSIBLE TO PATCH AND MAKE GOOD ALL EXISTING CONSTRUCTION AFFECTED BY THE REMOVAL OF ALL ITEMS FORMING THE PART OF THE RENOVATION WORK.


PLUMBING INSTALLATION SHALL CONFORM TO NATIONAL PLUMBING CODE OF CANADA.


THE CONTRACTOR IS RESPONSIBLE FOR INSTALLING RISERS, SWING JOINTS AND DEEP CUP ESCUTCHEONS AS REQUIRED.

ELECTRICAL WIRING SHALL BE PERFORMED BY A QUALIFIED ELECTRICAL SUBTRADE.

PROVIDE MILCOR ACCESS DOORS IN DRYWALL CEILINGS AND WALLS FOR ACCESS TO MECHANICAL EQUIPMENT. MINIMUM SIZE 24" X 18".

THE MECHANICAL CONTRACTOR SHALL ARRANGE WITH MANITOBA HYDRO GAS DIVISION FOR REVISION TO GAS SERVICE INCLUDING PRESSURE REGULATOR. THE COST OF THIS SERVICE SHALL BE INCLUDED IN THE COST OF THIS CONTRACT.

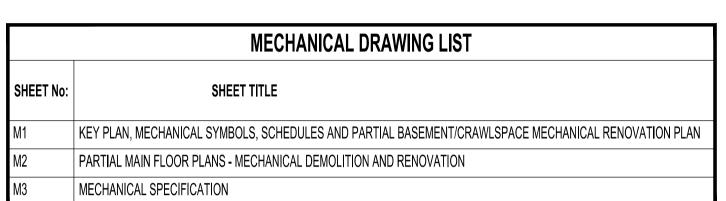

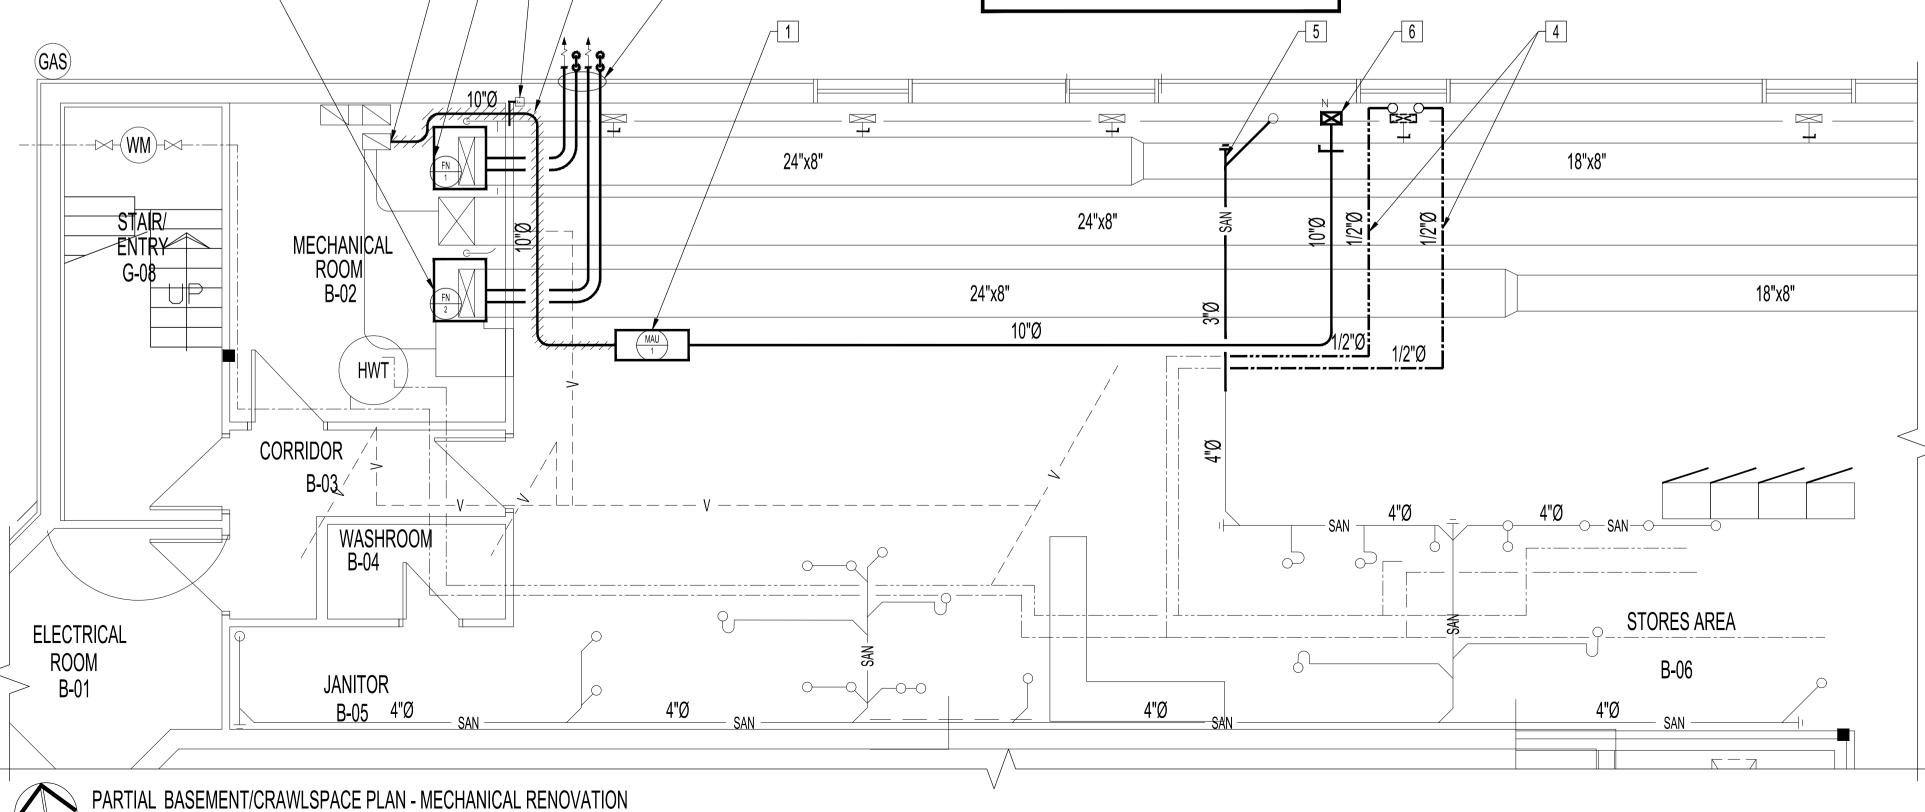

EXISTING THERMOSTAT TO BE REMOVED

NEW THERMOSTAT

————— DOMESTIC COLD WATER PIPING

— - - — DOMESTIC HOT WATER PIPING

——SAN—— SANITARY DRAIN PIPING ABOVE SLAB

---SAN--- SANITARY DRAIN PIPING BELOW SLAB

NORMALLY CLOSED SHUT OFF VALVE

PLUMBING FIXTURE DESIGNATION

FLOOR DRAIN

—— SHUT OFF VALVE

⊢ CLEANOUT


——GAS—— NATURAL GAS LINE


——∨—— VENT LINE


EQUIPMENT DESIGNATION

PARTIAL BASEMENT/CRAWLSPACE MECHANICAL RENOVATION NOTES:

- 1 NEW ELECTRIC MAKE UP AIR UNIT. INTERLOCK WITH NEW RANGE HOOD EXHAUST FAN. SUSPEND FROM STRUCTURE C/W VIBRATION ISOLATOR AND FLEXIBLE CONNECTION.
- 2 NEW 10"Ø FRESH AIR DUCTWORK CONNECTED TO EXISTING 14"x8" FRESH AIR INTAKE AT THIS LOCATION.
- 3 PROVIDE 2" DUCT INSULATION TO FRESH AIR INTAKE DUCT.
- 4 NEW 1/2"Ø HOT AND COLD SUPPLY LINES CONNECTED TO EXISTING. UP TO NEW MAIN FLOOR KITCHEN SINK.
- 5 NEW 3"Ø SANITARY DRAIN LINE CONNECTED TO EXISTING SANITARY DRAIN. UP TO NEW OIL INTERCEPTOR ON MAIN FLOOR.
- 6 NEW 10"x6" MAKE UP AIR DUCT UP TO MAIN FLOOR.
- 7 NEW FIRE DAMPER.
- 8 DISCONNECT AND REMOVE EXISTING FURNACE F-1 AND COOLING COIL. CAP OFF F-1 CHIMNEY OPENING. INSTALL NEW HIGH EFFICIENCY GAS FIRED FURNACE FN-1 AND NEW DX COOLING COIL. FOLLOW MANUFACTURER'S RECOMMENDATIONS FOR
- 9 DISCONNECT AND REMOVE EXISTING FURNACE F-2 AND COOLING COIL. CAP OFF F-2 CHIMNEY OPENING. INSTALL NEW HIGH EFFICIENCY GAS FIRED FURNACE FN-2 AND NEW DX COOLING COIL. FOLLOW MANUFACTURER'S RECOMMENDATIONS FOR INSTALLATION. REPLACE EXISTING THERMOSTAT WITH NEW.
- 10 NEW FURNACE DIRECT VENT PENETRATING SIDEWALL.

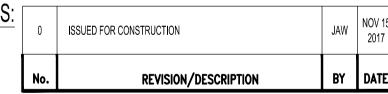

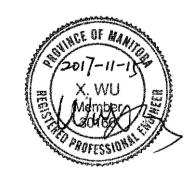

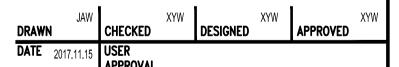



SHEET TITLE

THE CITY OF WINNIPEG PLANNING, PROPERTY AND
DEVELOPMENT DEPARTMENT
MUNICIPAL ACCOMMODATIONS DIVISION
3-65 GARRY STREET, R3C 4K4

PROJECT WINNIPEG FIRE PARAMEDIC SERVICES FIRE STATION #2

55 WATT STREET BID OPP: 1013-2017

KEY PLAN, MECHANICAL SYMBOLS SCHEDULES AND BASEMENT/CRAWLSPACE MECHANICAL RENOVATION PLAN

SHEET No: AS SHOWN

DRAWING SHEET SIZE: A1 (841mm x 594mm) PLOT 1:1