
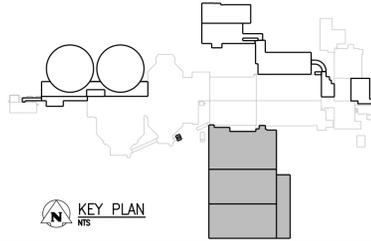


A1 SIZE - 594mm x 841mm

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- NOTES:**
- REFER TO DRAWING 1-0102-SGAD-A001 FOR GENERAL STRUCTURAL NOTES.
 - A MINIMUM LEVEL OF COMPACTED BACKFILL AT WEST AND EAST ENDS OF BIOREACTOR TANKS IS REQUIRED FOR OPERATION. TANKS MUST BE EMPTIED PRIOR TO EXCAVATING BELOW THIS ELEVATION. SEE DRAWING FOR ELEVATIONS.

OVERALL UPPER LEVEL/ROOF PLAN
1:200

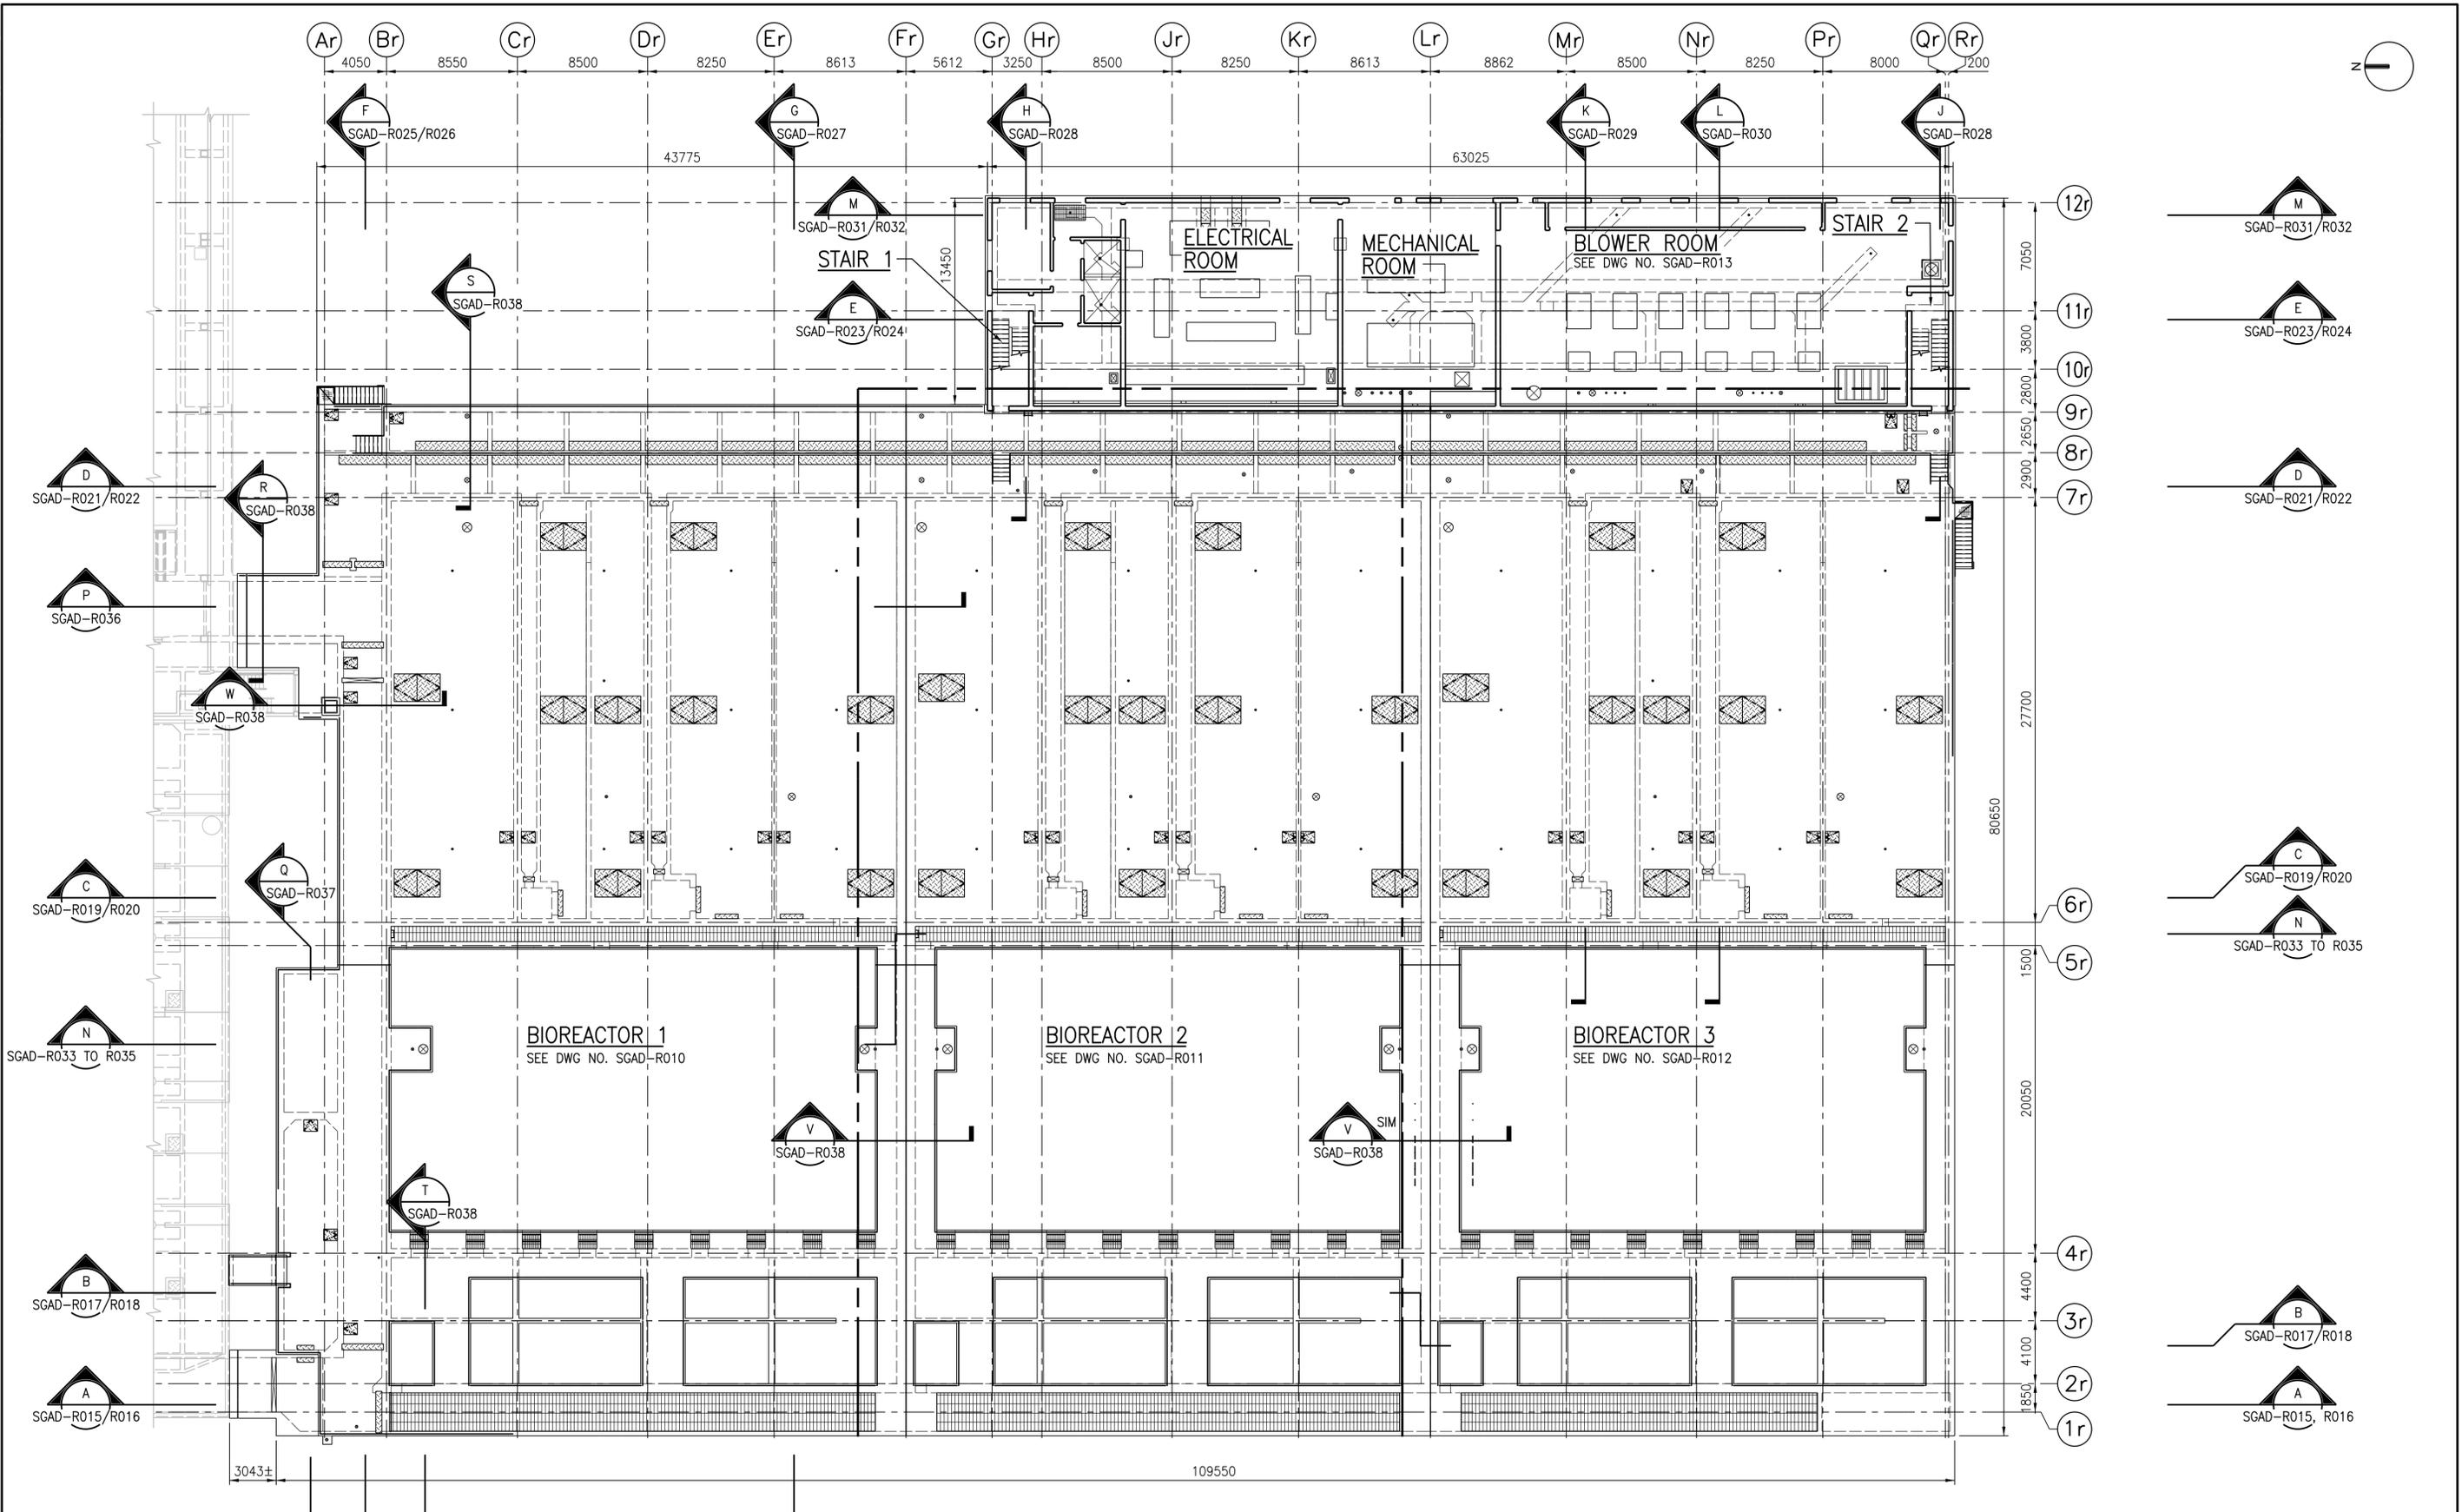

APEGM
Certificate of Authorization
CH2M HILL Canada Ltd.
No. 1441

NO.	REVISIONS	DATE	DESIGN	CHECK
00	ISSUED FOR TENDER - B.O. 899-2015	01/2016	C.R.	J.C.

CH2MHILL
SNC-LAVALIN

DESIGNED BY: J. THANNICKAL	CHECKED BY: E. LUI
DRAWN BY: C. RYNARD	APPROVED BY: H.T. FREIHAMMER
SCALE: 1:200	ISSUED FOR CONSTRUCTION BY: T. TURZAK
DATE: 2016/01/29	DATE: 2016/01/29
CONSULTANT NO.: 474248	

ENGINEER'S SEAL
31/01/2016
PROVINCE OF MANITOBA
S.I.E. LUI
Member
37003
REGISTERED PROFESSIONAL ENGINEER

THE CITY OF WINNIPEG
Winnipeg
WATER AND WASTE DEPARTMENT

SOUTH END WATER POLLUTION CONTROL CENTRE
SEWPCC UPGRADING/EXPANSION PROJECT
STRUCTURAL
BIOREACTORS/BLOWER BUILDING
OVERALL UPPER LEVEL/ROOF PLAN

CITY DRAWING NUMBER 1-0102-SGAD-R009	SHEET 001	REV. 00	SIZE A1
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