



GROUND FLOOR PLAN (EL. 234.392)

1:50

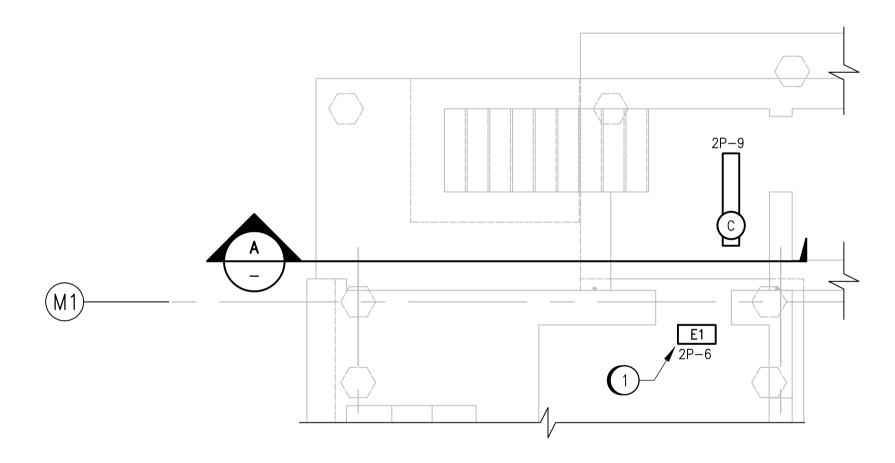

BASEMENT PLAN (EL. 227.380)

1:50

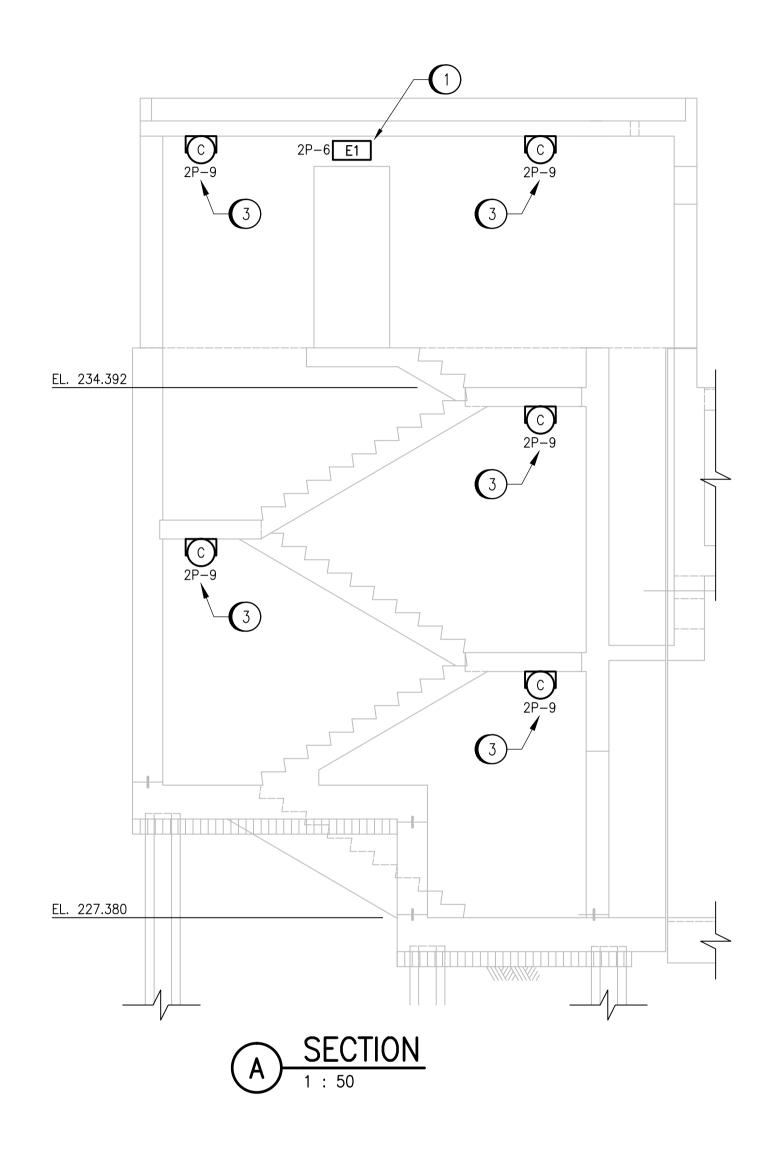

GENERAL NOTES

- 1. REFER TO SCHEDULE ON DWG. 1-0102-ESCH-A002 FOR LIGHTING FIXTURE AND EXIT SIGN MODEL NUMBERS.
- 2. THIS DRAWING SHOWS BOTH THE CROSS-SECTION VIEW OF THE ENTIRE STAIRWELL AND THE FLOOR PLAN OF THE STAIRWELL. THEREFORE, THERE ARE SOME LIGHTING FIXTURES AND EXIT SIGNS THAT APPEAR TWICE ON THE DRAWING.
- 3. PROVIDE DEMOLITION OF THE EXISTING STAIRWELL. REMOVE REDUNDANT WIRING AND CONDUIT. PULL WIRING/CONDUIT BACK TO REMAINING FACILITIES IN ORDER TO RE-USE EXISTING CIRCUITS AS SHOWN. ENSURE THAT WIRING ADJUSTMENTS DO NOT IMPACT ONGOING PLANT OPERATION. RE-WIRE EXISTING SYSTEM AS REQUIRED TO MAINTAIN OPERATION.
- 4. ALL WIRING SHALL BE RUN IN RIGID, THREADED ALUMINUM CONDUIT.
- 5. THE PRIMARY CLARIFIER AREA IS A CLASS I, ZONE 2 AND CATEGORY 2 WET LOCATION. WIRING METHODS AND DEVICES SHALL COMPLY WITH THE CEC AND SPECIFICATION REQUIREMENTS.

SPECIFIC NOTES

- SUPPLY AND INSTALL NEW RUNNING MAN EXIT SIGN. EXTEND WIRING AND CONDUIT AS REQUIRED FOR CONNECTION TO CCT. 2P-6.
- SUPPLY AND INSTALL NEW HAZARDOUS RATED RUNNING MAN EXIT SIGN AT THE NEW STAIRWELL ENTRANCES AS SHOWN. EXTEND WIRING AND CONDUIT AS REQUIRED FOR CONNECTION TO CCT. 2P-6.
- SUPPLY AND INSTALL NEW 347 VAC LIGHTS IN THE NEW STAIRWELL. EXTEND WIRING AND CONDUIT AS REQUIRED. CONNECT TO EMERGENCY NIGHT LIGHT CCT. 2P-9.
- SUPPLY AND INSTALL NEW 347 VAC EXTERIOR LIGHT C/W PHOTOCELL AT EXTERIOR DOOR. EXTEND WIRING AND CONDUIT AS REQUIRED FOR CONNECTION TO CCT. 2P-10.

Ċί.					
_wbg\mw012;					
C:\pw_workdir\ch2mhill_	SEP-278	EXISTING CLARIFIERS — EL. 227.38M, EL.229 M & 230.12M,			
rkdir∖c	SLI 270	ELECTRICAL — LIGHTING			
_wo	SEP-277	EXISTING CLARIFIERS — EL. 234M & 238M, ELECTRICAL — LIGHTING			
.\pw	1-0102-ESCH-P001	PANEL SCHEDULE, PRIMARY CLARIFIERS			
	1-0102-ESCH-A002	SCHEDULE — LUMINAIRES AND EXIT SIGNS			
эатн:	REFERENCE DRAWINGS	DESCRIPTION			

APEGIN Certificate of Authorization SNC-Lavalin Inc. No. 4489

						CH2N	ENGINEER'S SEAL	
F						SNC·LAVALIN	KGS GROUP CONSULTING ENGINEERS	
						DESIGNED BY:	CHECKED BY:	
						V. ELIMBAN	D. BECKER	PRELIMINARY
						DRAWN BY: MJ. PERSSON	APPROVED BY: D. BECKER	NOT FOR CONSTRUCTION
						SCALE: 1:30	ISSUED FOR CONSTRUCTION BY:	
						DATE: 2015/03/12	DATE:	
	00	ISSUED FOR TENDER	08/2015	WE	DEB	CONCLUTANT NO :		
ᆛᅟ	NO.	REVISIONS	DATE	DESIGN	CHECK	474248		

PLOT DATE: Aug 12, 2015 - 2:12pm

THE CITY OF WINNIPEG WATER AND WASTE DEPARTMENT

SOUTH END WATER POLLUTION CONTROL CENTRE SEWPCC UPGRADING/EXPANSION PROJECT ELECTRICAL - LIGHTING PLAN LAYOUT PRIMARY CLARIFIERS STAIRWELL

FILE NAME:1-0102-ELTG-P001.dwg