
LEGEND							
Α	STRIP FLUORESCENT LIGHT (A DENOTES TYPE)	ৰু ১	EMERGENCY BATTERY BANK UNIT C/W HEAD LIGHTS	D/	POWER PANELBOARD - SURFACE MOUNT/FLUSH MOUNT	F	MANUAL PULL STATION
В	1'x4' FLUORESCENT LIGHT (B DENOTES TYPE)	EOLR	END OF LINE RESISTOR	 	SYSTEM PANELBOARD - SURFACE MOUNT/FLUSH MOUNT	H)	FIRE ALARM SIGNAL HORN & STROBE
С	2'x4' FLUORESCENT LIGHT (C DENOTES TYPE)	\$ ³	SINGLE POLE SWITCH (3 DENOTE 3 WAY SWITCH)	\boxtimes	TRANSFORMER	● 10"	FIRE ALARM BELL (10") C/W STROBE LIGHT
D	2'x2' FLUORESCENT LIGHT (D DENOTES TYPE)	2	MOTION SENSOR SWITCH (WALL MOUNTED)	(4)	ELECTRIC METER	SECKI	SECURITY HORN
E	H.I.D. OR INCANDESCENT FIXTURE (F DENOTES TYPE)	D)	HANDI-CAP SECURITY PUSH BUTTON		TELEPHONE BACKBOARD	•	PUSH BUTTON
oG	POT LIGHT (G DENOTES TYPE)	HD	HAND DRYER	▼	VOICE/DATA OUTLET	Đ)	HANDI-CAP SECURITY PUSH BUTTON
	WALL MOUNTED LIGHT FIXTURE (H DENOTES TYPE)	+	DUPLEX RECEPTACLE	∇	DATA OUTLET	•	DOOR CONTACT (FLUSH IN FRAME)
₩ ^	NURSE CALL SYSTEM DOME LIGHT	Ø Φ	DUPLEX RECEPTACLE - ABOVE COUNTER (GFCI)	∳ ₽	MOTOR AND DISCONNECT	ER	EXISTING TO BE REMOVED
<u>\$</u>		φ·	DUPLEX RECEPTACLE - GROUND FAULT CIRCUIT INTERRUPTER	B1000	BASEBOARD HEATER (1000 DENOTES 1000 WATTS)	EX	EXISTING TO REMAIN
	PHOTOCELL SIDE ALABA CIONAL HODAL & STRORE (CEILING MOLINIT)	#	FOURPLEX RECEPTACLE (QUAD)		FORCE FLOW HEATER	EL	EXISTING TO RELOCATED
(((((((((((((()))))	FIRE ALARM SIGNAL HORN & STROBE (CEILING MOUNT)		MAGNETIC DOOR HOLDER	<u> </u>	UNIT HEATER	R	RELOCATED EXISTING (SHOWN IN NEW LOCATION)
(((○))	FIRE ALARM SIGNAL STROBE (CEILING MOUNT)	(M)	CARBON MONOXIDE DETECTOR	(T)	THERMOSTAT	N	NEW
<u>४</u> ८ / №	EMERGENCY LIGHT (REMOTE - 2 HEADS)	CO		S	SMOKE DETECTOR (ADDRESSABLE)		
્ર <u>ઋ</u>	EMERGENCY LIGHT (SINGLE HEAD) EXIT LIGHT C/W DIRECTIONAL ARROWS AS SHOWN	K ⊗	SECURITY KEYPAD DIRECT CONNECT	 	HEAT DETECTOR (COMBINATION)		

DRAWING NOTES:


- EXISTING EMERGENCY HEADS TO BE REPLACED WITH NEW. REFER TO DRAWING E3.0. TYPICAL
- 2 EXISTING FIXTURE TO BE ROTATED TO SUIT NEW LAYOUT.
- 3 REMOVE LIGHTING WITHIN OFFICE.
- RELOCATE EXISTING COMMON AREA LIGHT SWITCHES TO NEW OFFICE. REFER TO E2.0.
- 5 RELOCATE EXISTING SURFACEMOUNT FLUORESCENT LIGHTING IN COMMON ROOM. REFER TO E2.0
- DISCONNECT EXISTING WASHROOM EXHAUST FANS. CONNECT NEW FANS TO EXISTING CIRCUIT.
- EXISTING DUPLEX RECEPTACLE TO BE REPLACED WITH GFCI RECEPTACLE.
- 8 RELOCATE EXISTING SECURITY KEYPAD TO NEW OFFICE M21.

GENERAL NOTE

- ELECTRICAL DEMO DRAWINGS E1.0 SHALL BE READ IN CONJUNCTION WITH ARCHITECTURAL, STRUCTURAL, MECHANICAL AND ELECTRICAL DRAWINGS. REFER TO ARCHITECTURAL DRAWINGS FOR COMPLETE SCOPE OF WORK.
- 2. E.C. SHALL COORDINATE ALL DEMOLITION WORK WITH G.C. IN EXISTING AREAS.
- 3. ALL EXISTING SYSTEMS/EQUIPMENT/DEVICES REQUIRING DISCONNECTION TO FACILITATE DEMOLITION SHALL BE RECONNECTED AND RETURNED TO FULLY OPERATIONAL CONDITION.
- 4. E.C. TO LOCATE/RELOCATE EXISTING SERVICES AS REQUIRED TO SUIT INTERIOR RENOVATION.
- 5. EXISTING LIGHT FIXTURES MARKED 'EL' AND ASSOCIATED LOW VOLTAGE SWITCH TO BE DISCONNECTED, REMOVED, BENCH CLEANED AND RELOCATED. REUSE EXISTING CIRCUIT, WHIPS AND CONTROLS WHENEVER POSSIBLE. REFER TO DRAWING E2.0 FOR NEW LIGHTING LAYOUT.

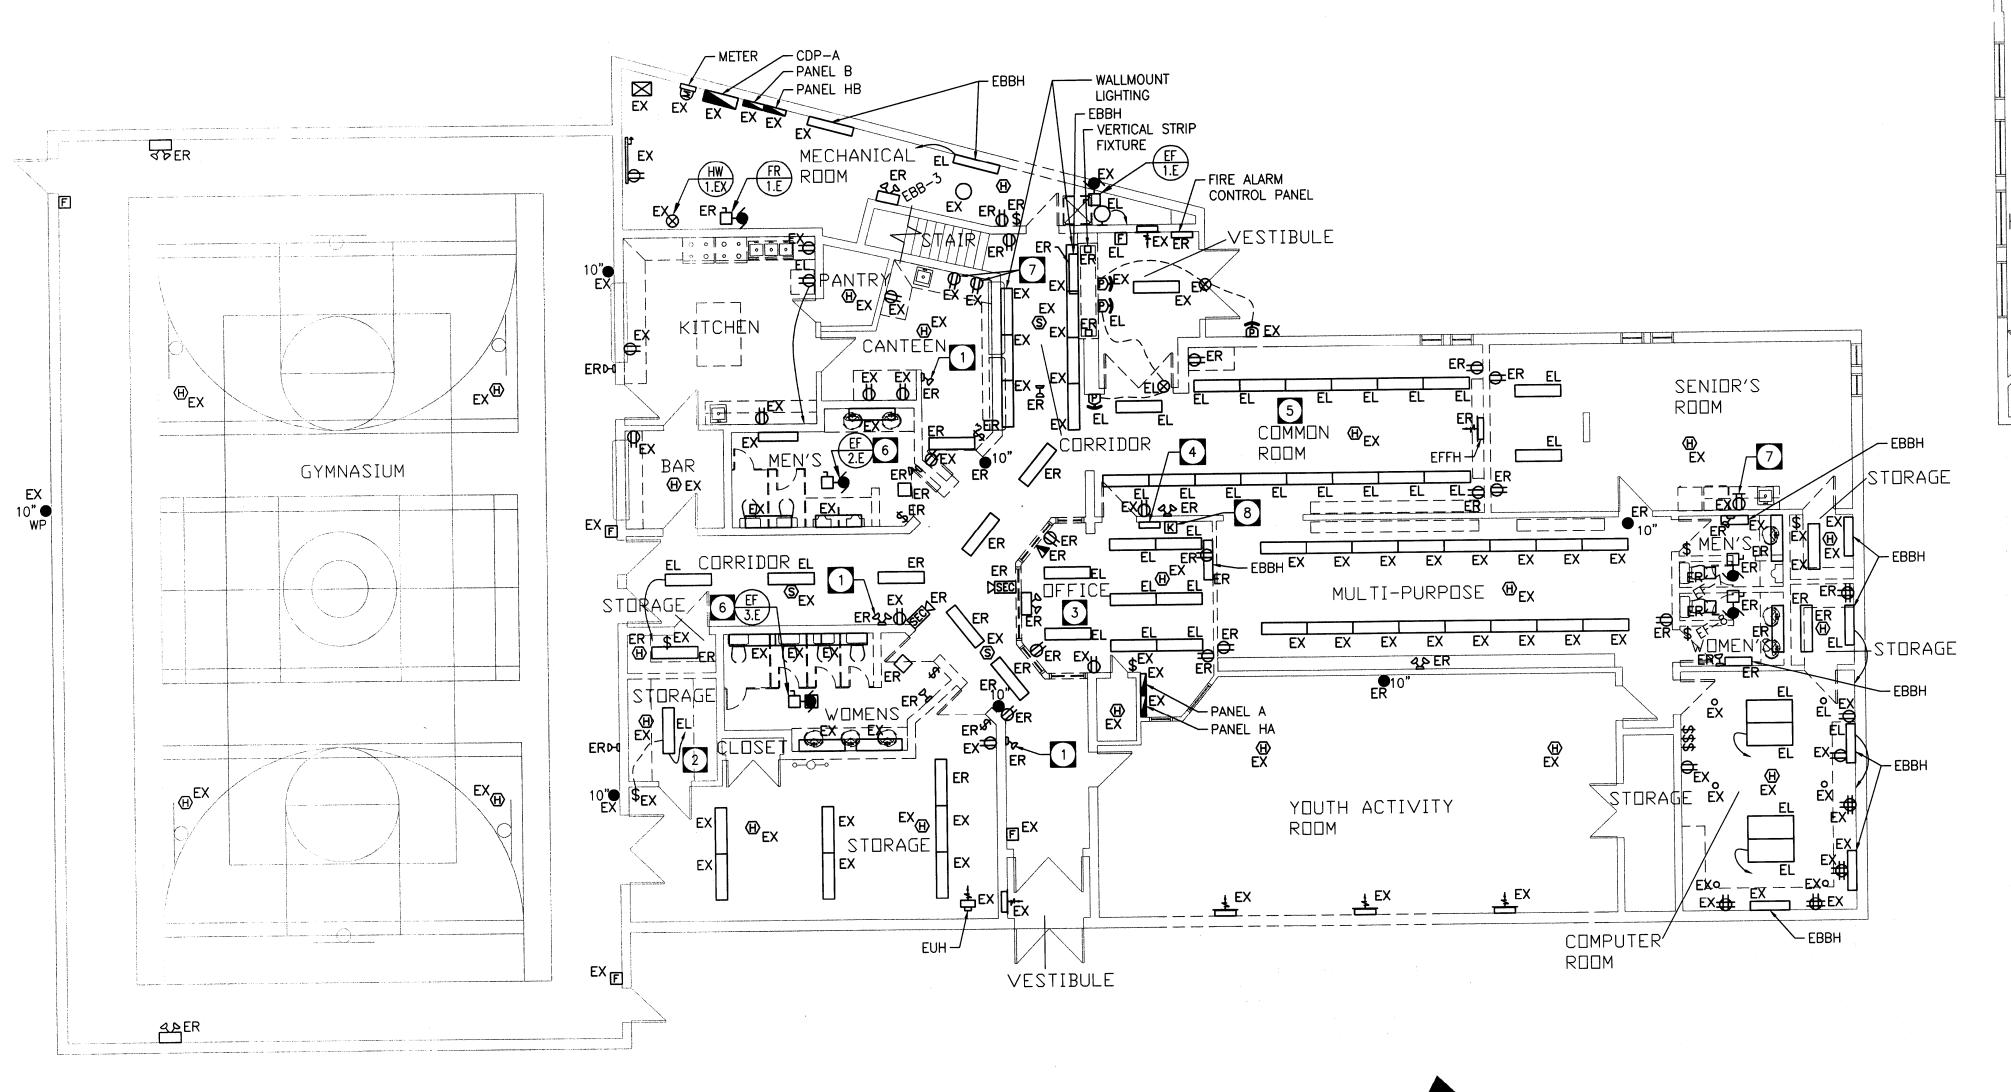



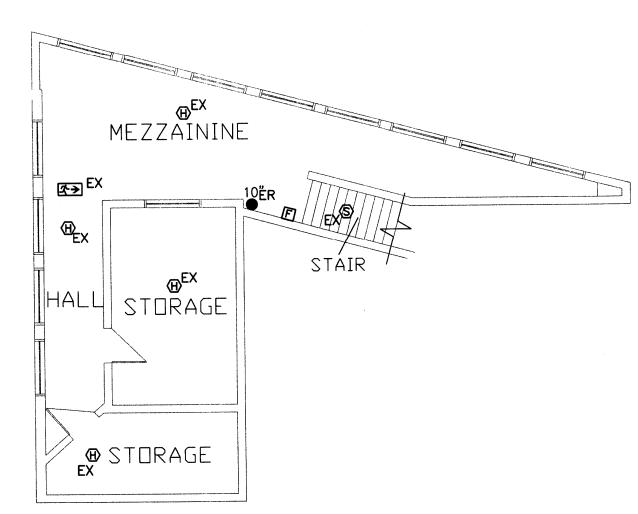

EXISTING MEZZANINE FLOOR PLAN SCALE: 1:100



APEGN Certificate of Authorization Tower Engineering Group No. 4156 Expiry: April 30, 2015

rev4 - 2014-09-29 - Issued for Construction rev3 - 2014-08-01 - Issued for 95% Review rev2 - 2014-06-27 - Issued for 75% Review rev1 - 2014-04-30 - Issued for 30% Review

The drawings, specifications, revisions, addendums, and clarifications, must be read as a whole. Errors and ommissions due to separation of the documents by the general contractor become the responsibility of the same.

This drawing must not be scaled.

The general Contractor must verify all dimensions, datums and levels prior to commencement of work. All errors and omissions must be reported immediately to the Architect.


Variations and modifications to work shown on this drawing shall not be carried out without written permission from the Architect.



TOWER PROJECT NO. :141033 TOWER ENGINEERING GROUP

UNIT 1 - 1140 WAVERLEY ST.
TEL: (204) 925-1150
EMAIL: towereng@towereng.ca

WINNIPEG, MB R3T 0P4
FAX: (204) 925-1155
WEB: www.towereng.ca

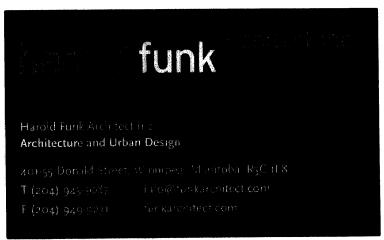

WESTON MEMORIAL COMMUNITY CENTRE - INTERIOR RENOVATION WINNIPEG, MANITOBA

sheet title **ELECTRICAL**

DEMO LAYOUT

drawing number: E1.0

September 30, 2014