
1-0102G-A0095

1-0102G-A0094

DRAWING NUMBER

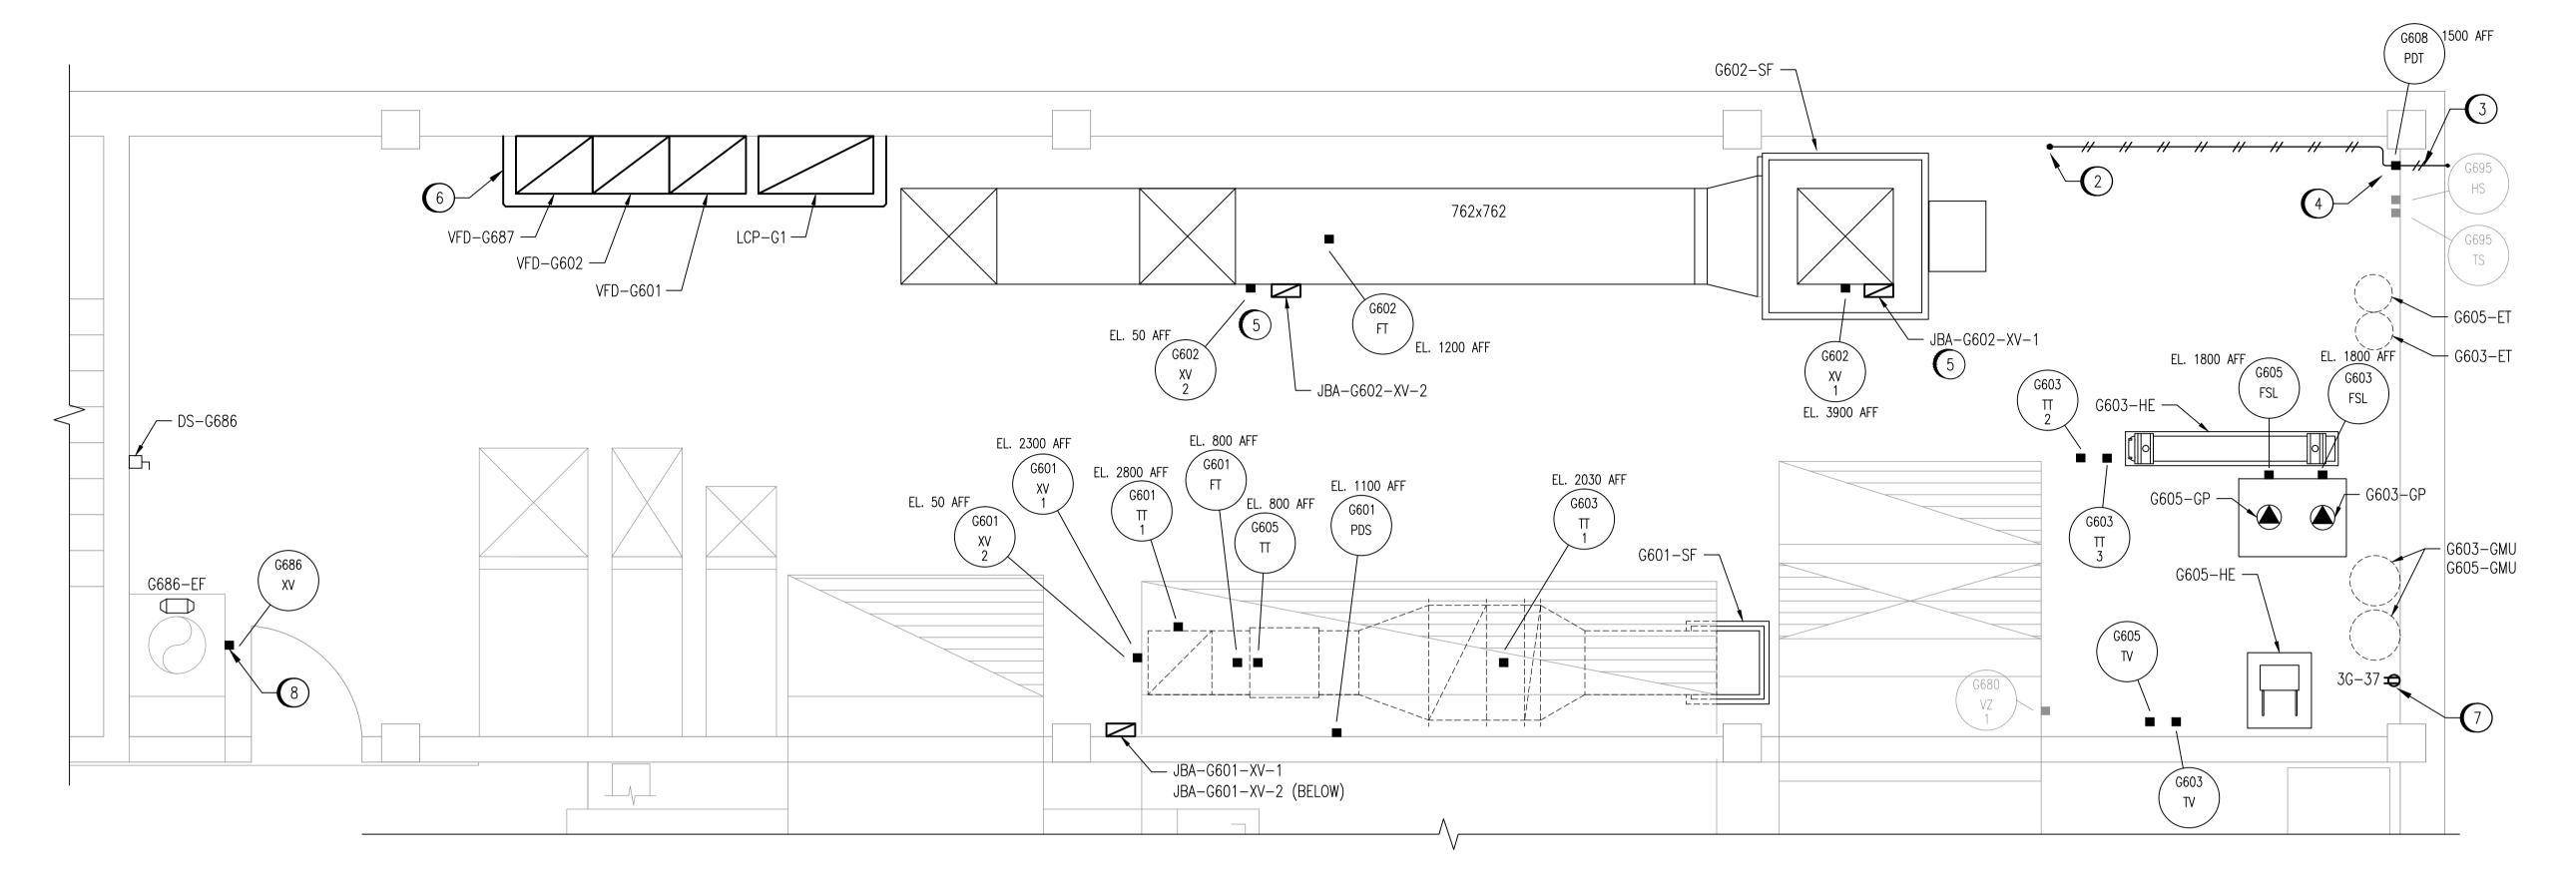

WET WELL MECHANICAL ROOM

300 0 300 900 1500 1 : 30

NO.	CONSTRUCTION NOTES
(1)	COORDINATE WITH CITY FOR REMOVAL OF EXISTING SHELVING.
2	DRILL HOLE THROUGH FLOOR TO WET WELL BELOW FOR G608-PDT. MARK OUT LOCATION OF REINFORCING STEEL PRIOR TO DRILLING TO AVOID CUTTING THROUGH STEEL. RUN STAINLESS STEEL TUBING ALONG WALL G608-PDT.
3	CONNECT PRESSURE TRANSMITTER TUBING TO ATMOSPHERE. SEE DETAIL ON 1-0102G-A0128.
4	PRESSURE TRANSMITTER TO BE HAZARDOUS CLASS 1, ZONE 2 RATED AS THE IMPULSE LINE IS CONNECTED TO THE WET WELL.
(5)	MOUNT JUNCTION BOXES ON UNISTRUT SUPPORTS.
6	INSTALL CONCRETE HOUSEKEEPING PAD UNDER ELECTRICAL EQUIPMENT. SEE 1-0102A-S0001 FOR DETAILS.
7	PROVIDE A DUPLEX RECEPTACLE FOR GLYCOL MAKE UP UNITS G603-GMU AND G605-GMU. PROVIDE CABLE FEEDING RECEPTACLE FROM PNL-3G.
(8)	PROVIDE NEW INSTRUMENT AIR PIPING FOR G686-XV. PAINT NEW PIPING TO MATCH EXISTING.

P&ID, WET WELL SUPPLY AND EXHAUST FANS, G602-SF, G686-EF, G687-EF

REFERENCE DRAWINGS

P&ID, WET WELL UPPER LEVEL HVAC, G601-SF

WET WELL MECHANICAL ROOM - G129	
KEY PLAN N.T.S.	

NOTES:

1. THIS DRAWING SUPERCEDES PART OF SEP-837.

APEGN Certificate of Authorization
SNC-Lavalin Inc.
No. 4489

					SNC·LAVALIN	SNC-LAVALIN INC. 148 Nature Park Way Winnipeg, MB, Canada R3P 0X7 204-786-8080	ENGINEER'S SEAL
					DESIGNED BY: T. CHURCH	CHECKED BY:	
					DRAWN BY: MJ. PERSSON	APPROVED BY: C. REIMER	•
					SCALE: 1 : 30	RELEASED FOR CONSTRUCTION BY: N. HARRINGTON	
					DATE: 2012/01/26	DATE: 2012/10/19	
00	ISSUED FOR TENDER, BID OPP. 545-2012	2012/11/21	TMC	CJR	CONSULTANT NO.: 112577-0116-48DD-0002		1
NΟ	REVISIONS	DATE	DESIGN	CHECK	1123//		

THE CITY OF WINNIPEG WATER AND WASTE DEPARTMENT

SOUTH END WATER POLLUTION CONTROL CENTRE VENTILATION & MISC UPGRADES INSTRUMENT LOCATION PLAN WET WELL MECHANICAL ROOM - G129

SHEET REV. SIZE 001 00 A1

1-0102G-A0097-001-00.dwg