

± 8 mm

± 12 mm

± 20 mm

VERIFY SIZE AND LOCATION OF ALL OPENINGS, CURBS AND EQUIPMENT PADS WITH PROCESS, MECHANICAL AND ELECTRICAL DRAWINGS AND PROCESS, MECHANICAL AND ELECTRICAL


DEFORMED BARS CONFORMING TO CAN/CSA G30.18, GRADE 400. LAP SPLICES AS PER CSA A23.3.

3. UNLESS SPECIFIED OTHERWISE HEREIN, TOLERANCES FOR REINFORCING STEEL REQUIREMENTS:

COVER SHALL IN NO CASE BE REDUCED BY MORE THAN 1/3 OF SPECIFIED COVER

CONTRACTORS. MAJOR OPENINGS NOT SHOWN TO BE VERIFIED WITH CONTRACT ADMINISTRATOR.


TEST CONCRETE IN ACCORDANCE WITH CAN/CSA A23.2. TEST RESULTS SHALL BE SUBMITTED TO CONTRACT ADMINISTRATOR. CONTRACTOR TO NOTIFY THE CONTRACT ADMINISTRATOR 48 HOURS

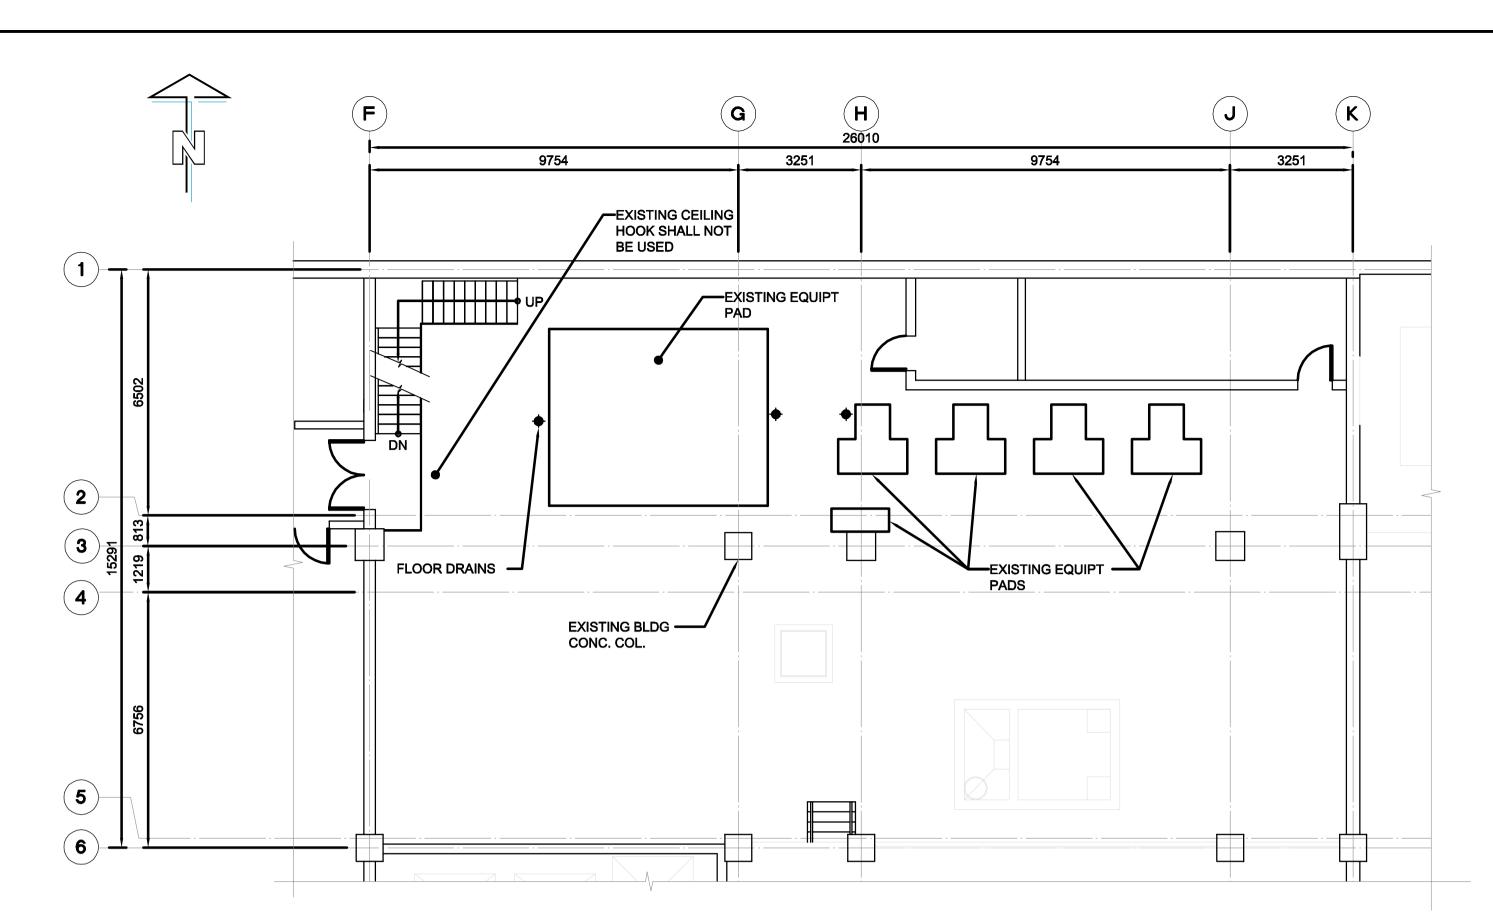


EXISTING SUB BASEMENT FLOOR PLAN

SCALE: 1:100mm

SCALE: 1:100mm

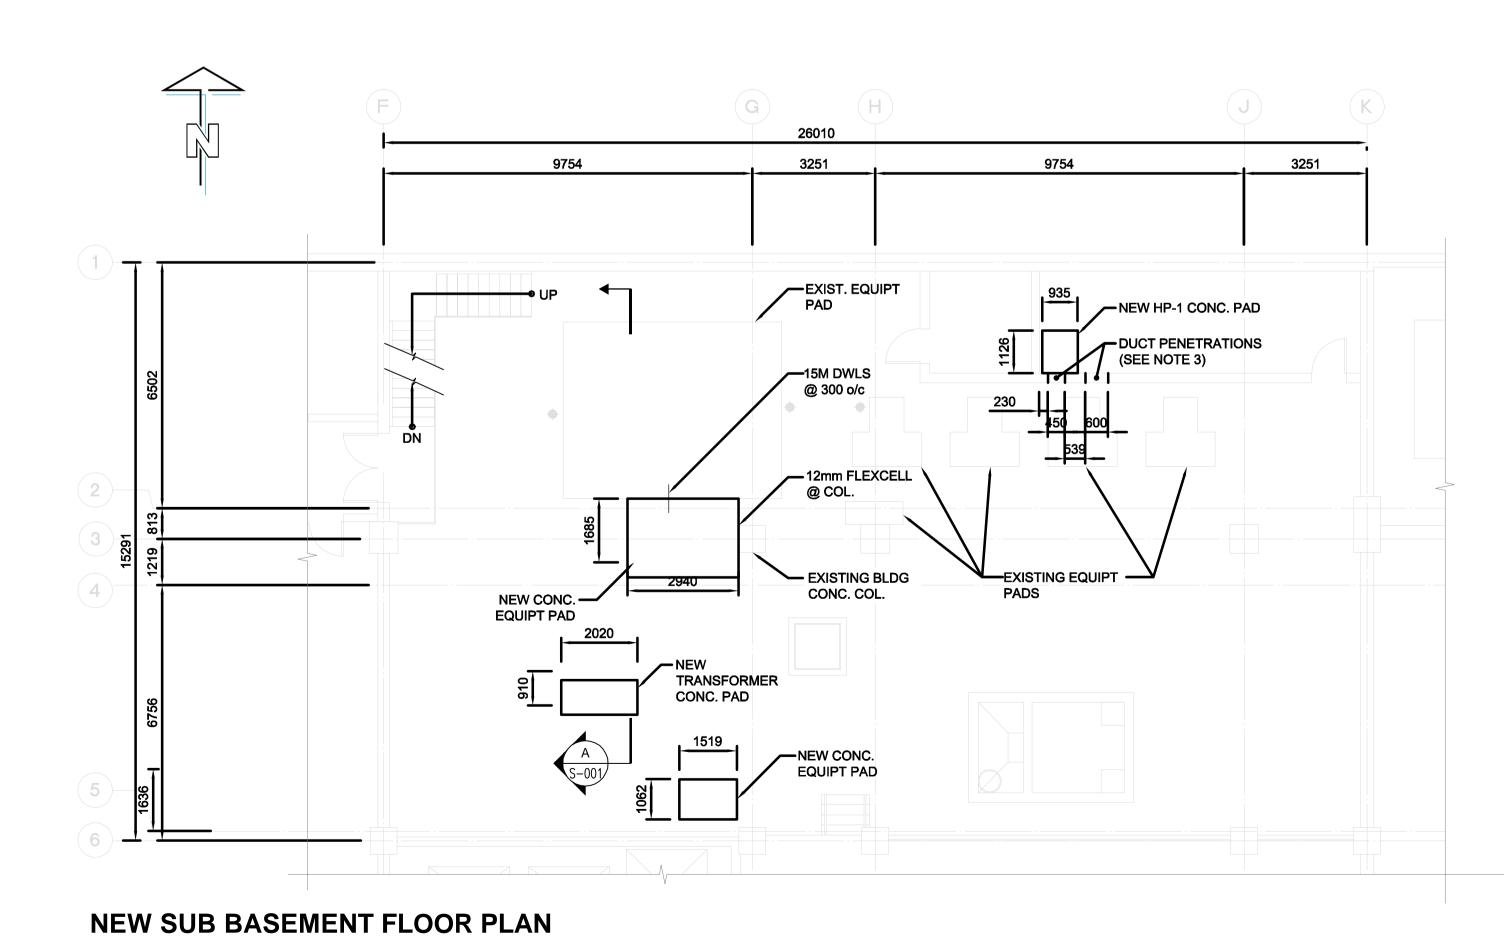

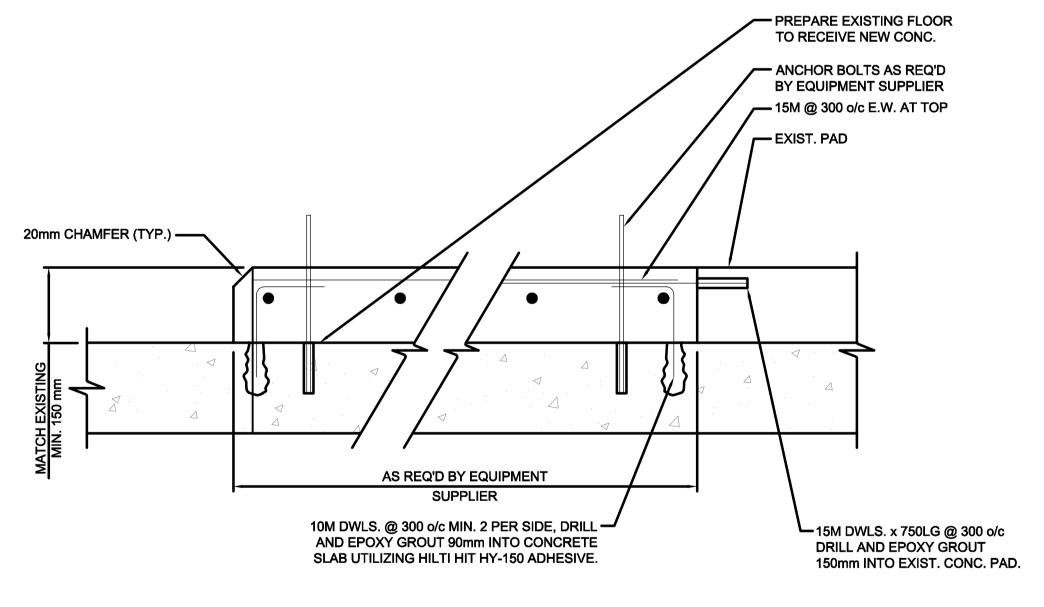

EQUIPMENT HOUSEKEEPING PAD S-001 SCALE: N.T.S.

CONCRETE NOTES

IN ADVANCE OF ALL CONCRETE CASTS.

CONCRETE CONSTRUCTION TOLERANCES:

300mm TO 1000mm

1000mm OR GREATER

CROSS SECTIONAL DIMENSIONS 300mm OR LESS

CSA EXPOSURE CLASS: C-2

REINFORCING STEEL NOTES

A) CONCRETE COVER

C) LOCATION OF BAR ENDS

B) LOCATION

CONCRETE SHALL MEET THE FOLLOWING REQUIREMENTS:

3. PROVIDE CLEAR 50mm CONCRETE COVER OVER REBAR AS FOLLOWS:

PROVIDE 20mm CHAMFER ON ALL EXPOSED CONCRETE CORNERS.

2. REINFORCING WORK SHALL BE IN ACCORDANCE WITH CSA 23.1 AND CSA 23.3.

ALL SECTIONS

SECTIONS < 200

ALL OTHERS

SECTIONS 200 TO 600


FOR NON-STRUCTURAL INTERIOR CONCRETE PADS: MINIMUM COMPRESSIVE STRENGTH (MPa): 32 @ 28 DAYS

- 1. FOR ALL HOUSEKEEPING PADS, SEE MECH'L. DWG FOR EXACT SIZES AND LOCATIONS.
- 2. EPOXY PAINT FINISH FOR ALL NEW AND EXISTING HOUSEKEEPING PADS.
- 3. MAKE GOOD ALL REPAIRS TO MATCH EXISTING WALL

FIRE RATING IS REQUIRED.

Certificate of Authorization AECOM Canada Ltd. No. 4671 Date:

	DRN	СНК	DES	ENG	IDR
_	AECOM REVIEW				

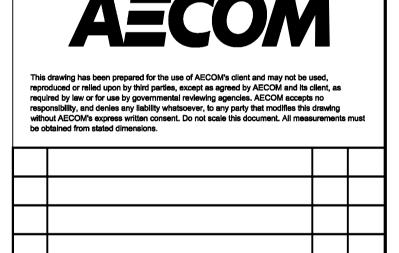

GLG 2011.11.03

± 12 mm

± 8 mm

± 12 mm

± 20 mm

± 50 mm

GGP DESIGNED APPROVED DATE 2011.09.02 USER APPROVAL

REVISION/DESCRIPTION



ISSUED FOR TENDER

PLANNING, PROPERTY AND DEVELOPMENT DEPARTMENT MUNICIPAL ACCOMMODATIONS DIVISION 3-65 GARRY STREET, R3C 4K4

PROJECT ADMINISTRATION & COUNCIL BUILDING

REPLACEMENT OF COOLING PLANT - 510 MAIN STREET BID OPPORTUNITY NO. 673-2011

510 MAIN STREET, WINNIPEG, MANITOBA SHEET TITLE

STRUCTURAL SUB BASEMENT FLOOR PLAN **EQUIPMENT PAD**

S-001

DRAWING SHEET SIZE: A1 (841mm x 594mm) PLOT 1:1