

- 1. 28 MPa CONCRETE ENVELOPE AFTER 28 DAYS.
- 2. No. 4 DEFORMED REINFORCING BARS.
- No. 3 DEFORMED REINFORCING TIES SPACED @ 610mm O.C. UNDER ROADWAYS, PARKING AREAS ETC. & @ 1530mm O.C. IN OTHER AREAS.
- 4. 4" (100mm) TYPE 2 RIGID CONDUIT FOR CONCRETE ENCASEMENT
- MOLDED PLASTIC INTERLOCKING DUCT SPACERS AT 1530mm

INTERVALS ALONG ENTIRE LENGTH OF DUCT BANK.

- 6. ALL LONGITUDINAL REINFORCING BARS TO BE WIRED TOGETHER TO No. 3 TIE BARS & TO PLASTIC SPACERS. LONGITUDINAL REINFORCING BAR SHALL OVERLAP 40 BAR DIA. MIN.
- DUCT BANK SHALL BE BURIED MIN. 900mm BELOW FINISHED 7. DUCT BANK SHALL BE BURIED MIN. 900mm BELOW FINISHED GRADE. PROVIDE 152mm WIDE CONTINUOUS RED STRIP TAPE ALONG DUCT RUN AT 305mm BELOW GRADE.
- 8. SEAL ALL DUCT ENDS AFTER CABLES ARE INSTALLED.

SECTIONS THROUGH DUCTBANKS

NOT TO SCALE

(SECONDARY HYDRO)

SECTIONS THROUGH DUCTBANKS NOT TO SCALE (TELEPHONE & TELEVISION)

8. SEAL ALL DUCT ENDS AFTER CABLES ARE INSTALLED.

DUCT RUN AT 305mm BELOW GRADE.

1. 28 MPa CONCRETE ENVELOPE AFTER 28 DAYS.

No. 3 DEFORMED REINFORCING TIES SPACED @ 610mm O.C.

UNDER ROADWAYS, PARKING AREAS ETC. & @ 1530mm O.C.

4. DUCTS TO BE RIGID TYPE 2 (100mm) FOR CONCRETE ENCASEMENT.

ALL LONGITUDINAL REINFORCING BARS TO BE WIRED TOGETHER

GRADE. PROVIDE 152mm WIDE CONTINUOUS RED STRIP TAPE ALONG

MOLDED PLASTIC INTERLOCKING DUCT SPACERS AT 1530mm

TO No. 3 TIE BARS & TO PLASTIC SPACERS. LONGITUDINAL

REINFORCING BAR SHALL OVERLAP 40 BAR DIA. MIN.

INTERVALS ALONG ENTIRE LENGTH OF DUCT BANK.

2. No. 4 DEFORMED REINFORCING BARS.

IN OTHER AREAS.


-FINISHED GRADE

NOTE #1-

NOTE #2-

NOTE #3-


1830mm

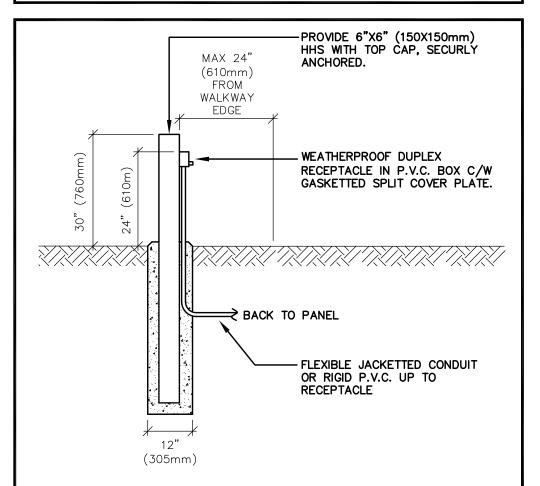

EXTERIOR MOUNTED RECEPTACLE

GENERAL SITE PLAN NOTES:

- DIMENSIONS AND LOCATIONS SHOWN ON THIS PLAN ARE APPROXIMATE ONLY. ALL BIDDERS SHALL PROVIDE ON SITE INSPECTIONS TO VERIFY EXACT DUCT LENGTHS AND LOCATIONS OF EXISTING STRUCTURES BEFORE SUBMISSION OF BID.
- WHERE EXISTING MATERIALS MUST BE REMOVED OR ALTERED TO FACILITATE INSTALLATION OF THE DUCTBANKS INDICATED, REPLACE MATERIALS AS REQUIRED TO MATCH ORIGINAL SITE CONDITIONS.
- ALL BENDS TO BE LONG SWEEP, FACTORY MADE WHERE AVAILABLE AND ALL DUCTS TO END WITH BELL ENDS AT MANHOLES AND OTHER
- REFER TO NEW SITE SERVICING PLANS AND OWNER'S RECORD DRAWINGS FOR BURIED SERVICES ALONG ROUTE OF NEW WORK. DO NOT UNDERMINE EXISTING SERVICES IF ENCOUNTERED AND MAINTAIN 150mm VERTICAL CLEARANCE AT CROSSINGS.
- CLEAN DUCTS AND INSTALL PULLWIRE IN EACH AFTER PLACEMENT OF OF CONCRETE.
- 6. ALL CONDUIT JOINTS TO BE WATERTIGHT.
- ALL DUCTBANKS TO BE MINIMUM 1.0m BELOW FINISHED GRADE TO TOP OF CONCRETE UNLESS OTHERWISE NOTED.
- 8. ALL UNDERGROUND ELECTRICAL SERVICES SHALL BE RUN MIN. 1220mm BELOW FINISHED GRADE UNLESS OTHERWISE NOTED.
- 9. REFER TO SITE SERVICES DRAWINGS FOR EXTENT AND APPROXIMATE LOCATION OF ALL UNDERGROUND SERVICES. CO-ORDINATE CROSSING OF THESE SERVICES CAREFULLY.
- 10. DIVISION 16, GENERAL TRADES AND SITE SERVICES SHALL CO-ORDINATE ALL SERVICES OVERLAPPING AT NEW SITE. CONFIRM ALL REQUIREMENTS AND ROUTING ON SITE PRIOR TO ANY CONSTRUCTION.

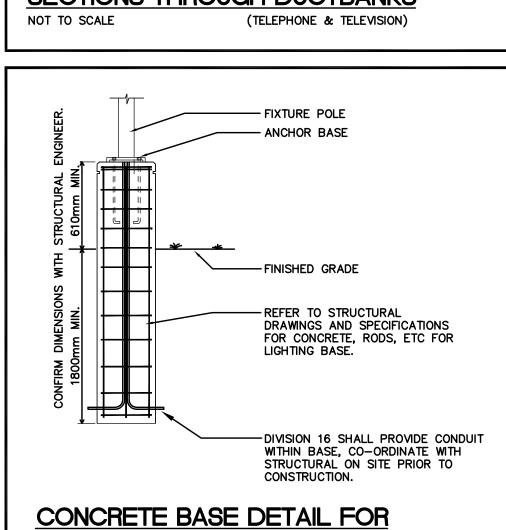


HYDRO NOTES;

FIXTURE TYPE

- 1. MANITOBA HYDRO FORCES SHALL SUPPLY AND INSTALL THE FOLLOWING:
- ALL MATERIAL UP TO AND INCLUDING PADMOUNT TRANSFORMER. -THE SECONDARY LUGS AND CONNECTION OF THE SECONDARY CONDUCTORS -TRANSFORMER PAD & FOUNDATION.
- -CONSTRUCT A PERIMETER GROUND GRADIENT CONTROL GRID. -GROUNDING & BONDING. -TERMINATE BOTH PRIMARY & SECONDARY CONDUCTORS.
- -SUPPLY REVENUE METERING EQUIPMENT TO ELECTRICAL CONTRACTOR. 2. DIVISION 16 SHALL SUPPLY AND INSTALL THE FOLLOWING;
- -CABLE FROM TRANSFORMER TO SWITCHGEAR. -SYSTEM NEUTRAL FROM TRANSFORMER TO CUSTOMER'S SWITCHGEAR & TO THE METERING SECTION OF SWITCHGEAR. -METER CABINET WITHIN ELECTRICAL ROOM.
- -31mm CONDUIT COMPLETE WITH PULLWIRE FROM CABINET TO SWITCHGEAR.
- DIVISION 16 SHALL PROVIDE THE FOLLOWING FOR COMMUNICATION SERVICES INTO BUILDING:

-RUN A TOTAL OF 2 @ 100mm (4") CONDUITS FROM PROPERTY LINE @ 915mm (36") BELOW GRADE INTO THE ELECTRICAL ROOM.

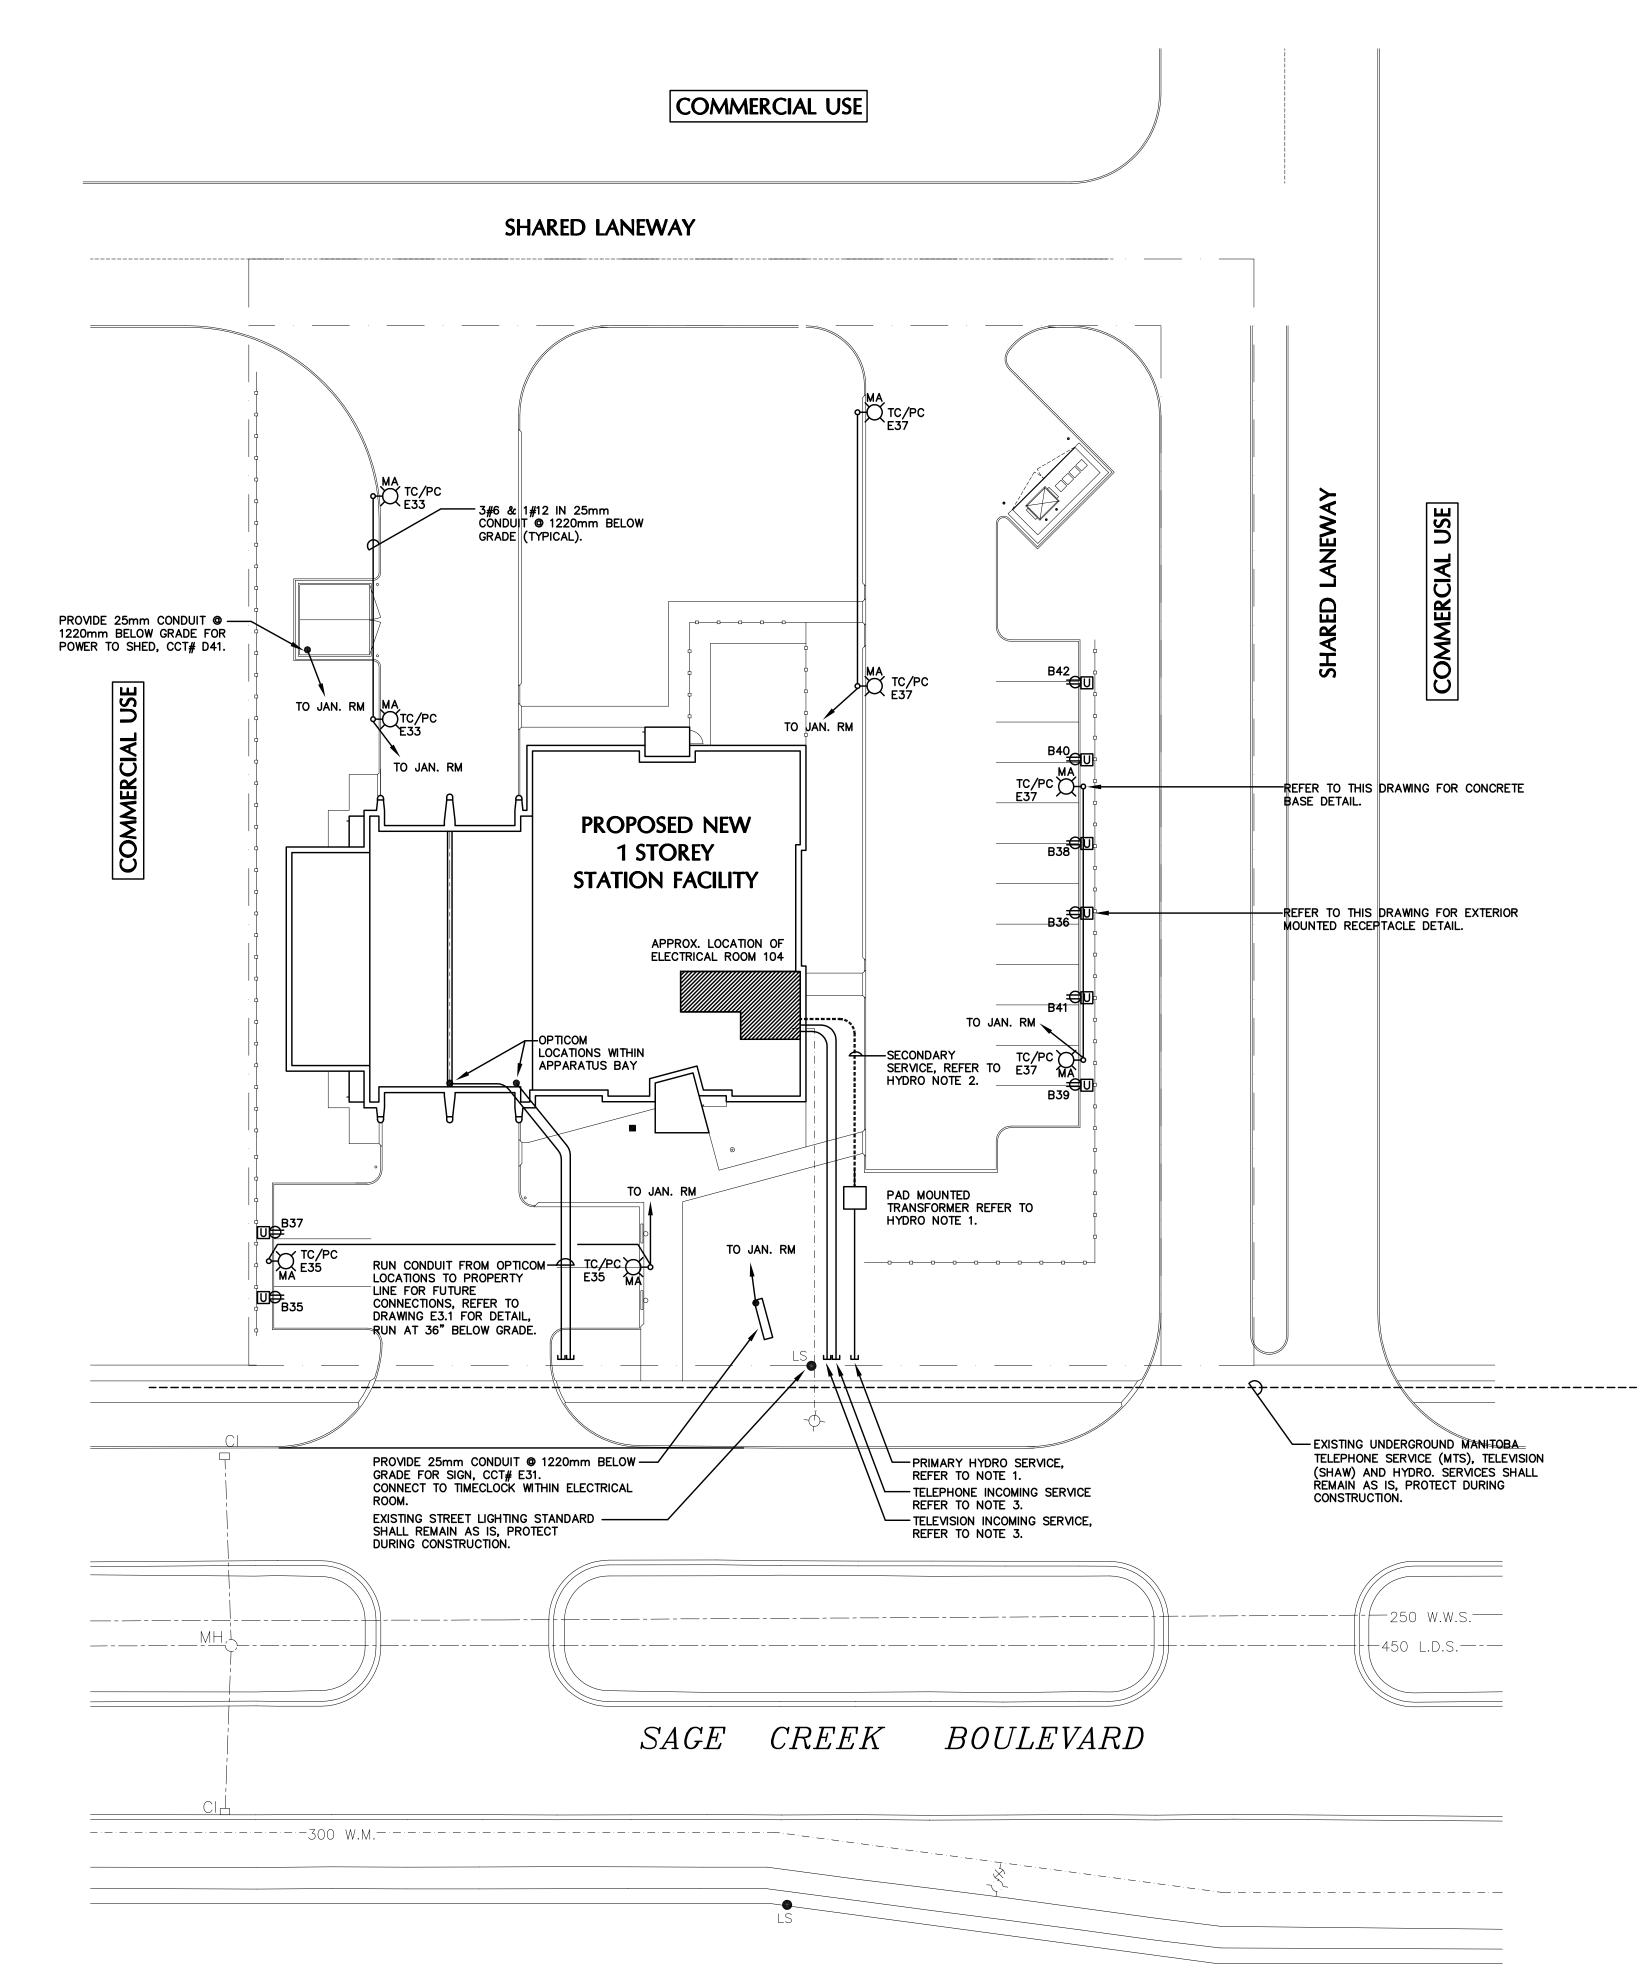

SITE PLAN ELECTRICAL LAYOUT

ISSUES: DATE DESCRIPTION MAY 14, 2010 | ISSUED FOR CLIENT REVIEW MAY 19, 2010 | ISSUED FOR CLIENT REVIEW 3 SEPT. 24, 2010 ISSUED FOR BUILDING PERMIT DEC. 10, 2010 ISSUED FOR TENDER



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PROJECT NAME:


NEW WINNIPEG STATION No. 27 PROJECT

SAGE CREEK, WINNIPEG, MANITOBA

DRAWING TITLE:

ELECTRICAL SITE PLAN

STAMP:

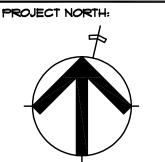

NOT VALID FOR CONSTRUCTION UNLESS SIGNI PROJECT NO .: SCALE: AS NOTED 2261 DECEMBER 10, 2010 FILE NAME:

ISSUED: DECEMBER 10, 2010 DRAWING NO.: DRAWN BY:

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