




PARKING RECEPTACLE I—BEAM MOUNTING DETAIL E6.1 SCALE: N.T.S.

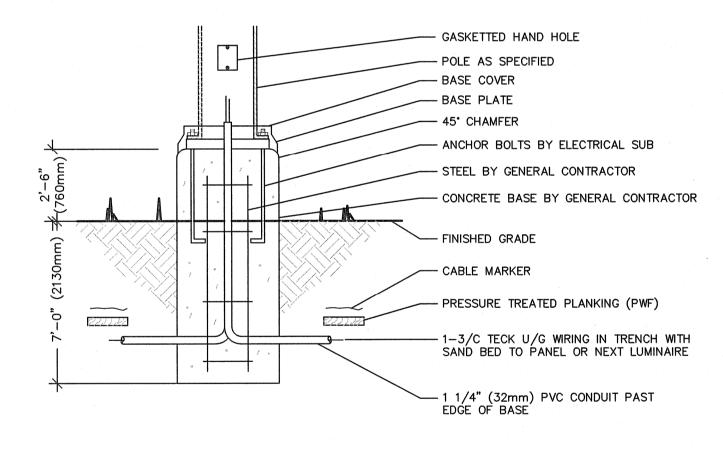

5 POLE MOUNTED LUMINAIRE BASE DETAIL E6.1 SCALE: N.T.S.

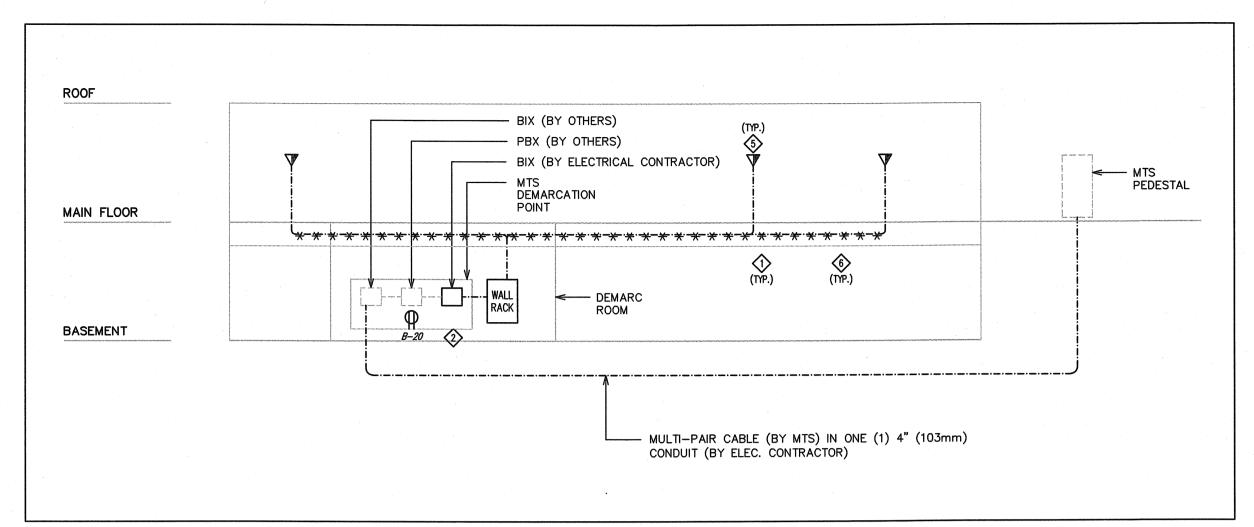

1 COMMUNICATIONS RISER DETAIL E6.1 SCALE: N.T.S.

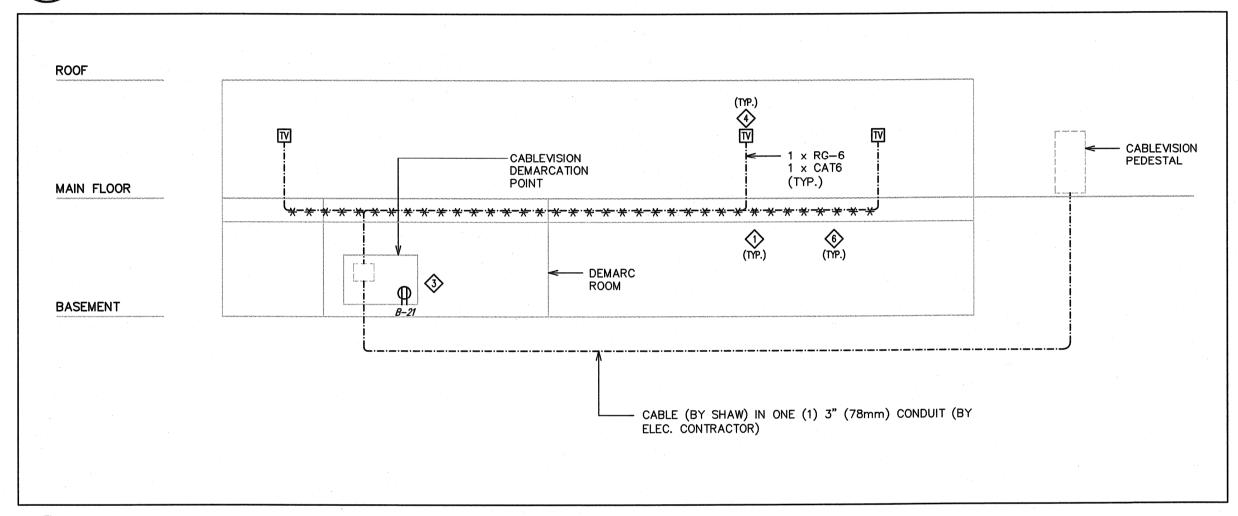

2 CABLEVISION RISER DETAIL E6.1 SCALE: N.T.S.

NOTES:

- 1. J-HOOKS UTILIZED FOR COMMUNICATIONS/TELEVISION CABLING BRANCH WIRING MOUNTED IN ACCESSIBLE CEILING SPACE. REFER TO COMMUNICATIONS J-HOOK FILL TABLE.
- TELEPHONE DEMARCATION POINT. PROVIDE 36" (900mm)
 COIL OF #6 AWG GREEN INSULATED COPPER WIRED AND
 CONNECT TO TGB IN COMMUNICATIONS CLOSET.
- 3. CABLEVISION DEMARCATION POINT. PROVIDE 36"
 (900mm) COIL OF #6 AWG GREEN INSULATED COPPER WRED AND CONNECT TO TGB IN COMMUNICATIONS
- 4. PROVIDE ONE RG-6 COAXIAL CABLE AND ONE CAT 6 CABLE FROM EACH TELEVISION OUTLET TO CABLEVISION DEMARCATION POINT.
- 5. PROVIDE MINIMUM OF TWO (2) CAT 6 CABLES FROM EACH COMMUNICATIONS OUTLET TO RACK UNLESS NOTED OTHERWISE.
- 6. PROVIDE CONDUIT SYSTEM FOR CABLING LOCATED IN NON-ACCESSIBLE CEILING SPACE AND AREAS WHERE CABLING IS ACCESSIBLE TO PUBLIC. REFER TO COMMUNICATIONS CONDUIT FILL TABLE.

COMMUNICATIONS CONDUIT FILL TABLE	
MINIMUM CONDUIT SIZE	MAXIMUM # OF CABLES (CAT 5, 5E, 6 OR HIGHER)
1" (27mm)	. 6
1-1/4" (35mm)	10
1-1/2" (41mm)	15
2" (53mm)	20
2-1/2"(63mm)	30

3" (78mm)

COMMUNICATIONS J-HOOK FILL TABLE	
J-HOOK SIZE	MAXIMUM # OF CABLES (CAT 5, 5E, 6 OR HIGHER)
3/4"	6
1-5/16"	20
2"	32
4"	120





FEB 26, 2010

FEB 10, 2010

JAN 08, 2010

DEC 02, 2009

D ISSUED FOR TENDER
C ISSUED FOR 99% REVIEW
B ISSUED FOR 90% REVIEW
A ISSUED FOR 60% REVIEW

This drawing must not be scaled.

The general Contractor must verify all dimensions, datums and levels prior to commencement of work. All errors and omissions must be reported immediately to the Architect.

Variations and modifications to work shown on this drawing shall not be carried out without written permission from the Architect.

This drawing is the exclusive property of the Architect and cannot be reproduced without written permission of the Architect. Reproduction must bear the name of the Architect. Copyright © 2009.



MCW / AGE

Consulting Professional Engineers
210-1821 Wellington Avenue
Winnipeg, Manitoba, R3H 0G4
Phone - (204) 779-7900 Fax - (204) 779-1119
E-Mail: mcw_wpg@mcw.com



project

SINCLAIR COMMUNITY
CENTRE
ADDITION & RENOVATIONS
490 Sinclair Street, Winnipeg

sheet title

DETAILS

project number: 5878
scale: N.T.S.
drawn by: P.A.S.

2010-02-26

drawing number: