


PLAN - ELECTRICAL RM. (EL. 232.70m) SCALE: 1:50

GRILLE SCHEDULE						
GRILLE No.	E.H. PRICE DESIGNATION	COMMENTS				
G1 750x250/510/F/L/A/B12		LOUVERED RETURN GRILLE				

LOUVRE SCHEDULE					
LOUVRE No.	SIZE (WxH)	ACCEPTABLE MATERIAL			
L1	300x400 (12"x16")	E.H.PRICE/DE439			
L2	400x600 (16"x24")	E.H.PRICE/DE439			

FAN SCHEDULE									
TAG No. CAPACITY		E.S.P. FRPM	FRPM	VOLTAGE	MOTOR			ACCESSORIES	MAKE/MODEL
					HP	ENCL	RPM		·
EF-1	94 L/s	62.5 Pa	1550	120/1/60	1/40	TEAO	1550	SPRING HANGING ISOLATORS AND BRACKETS	"GREENHECK"/SQ-70-G
SF-1	660 L/s	88 Pa	1725	120/1/60	1/4	ODP	1725	SPRING HANGING ISOLATORS AND BRACKETS	"GREENHECK"/SQ-100-A

ELECTRIC UNIT HEATER SCHEDULE						
TAG No.	CAPACITY	VOLTAGE	CONTROLS	ACCESSORIES	MAKE/MODEL	
UH-1	5.0 kW	600/3/60	REMOTE SPACE THERMOSTAT	MOUNTING BRACKET AND SPACE THERMOSTAT	"CALORITECH"/GE058C	

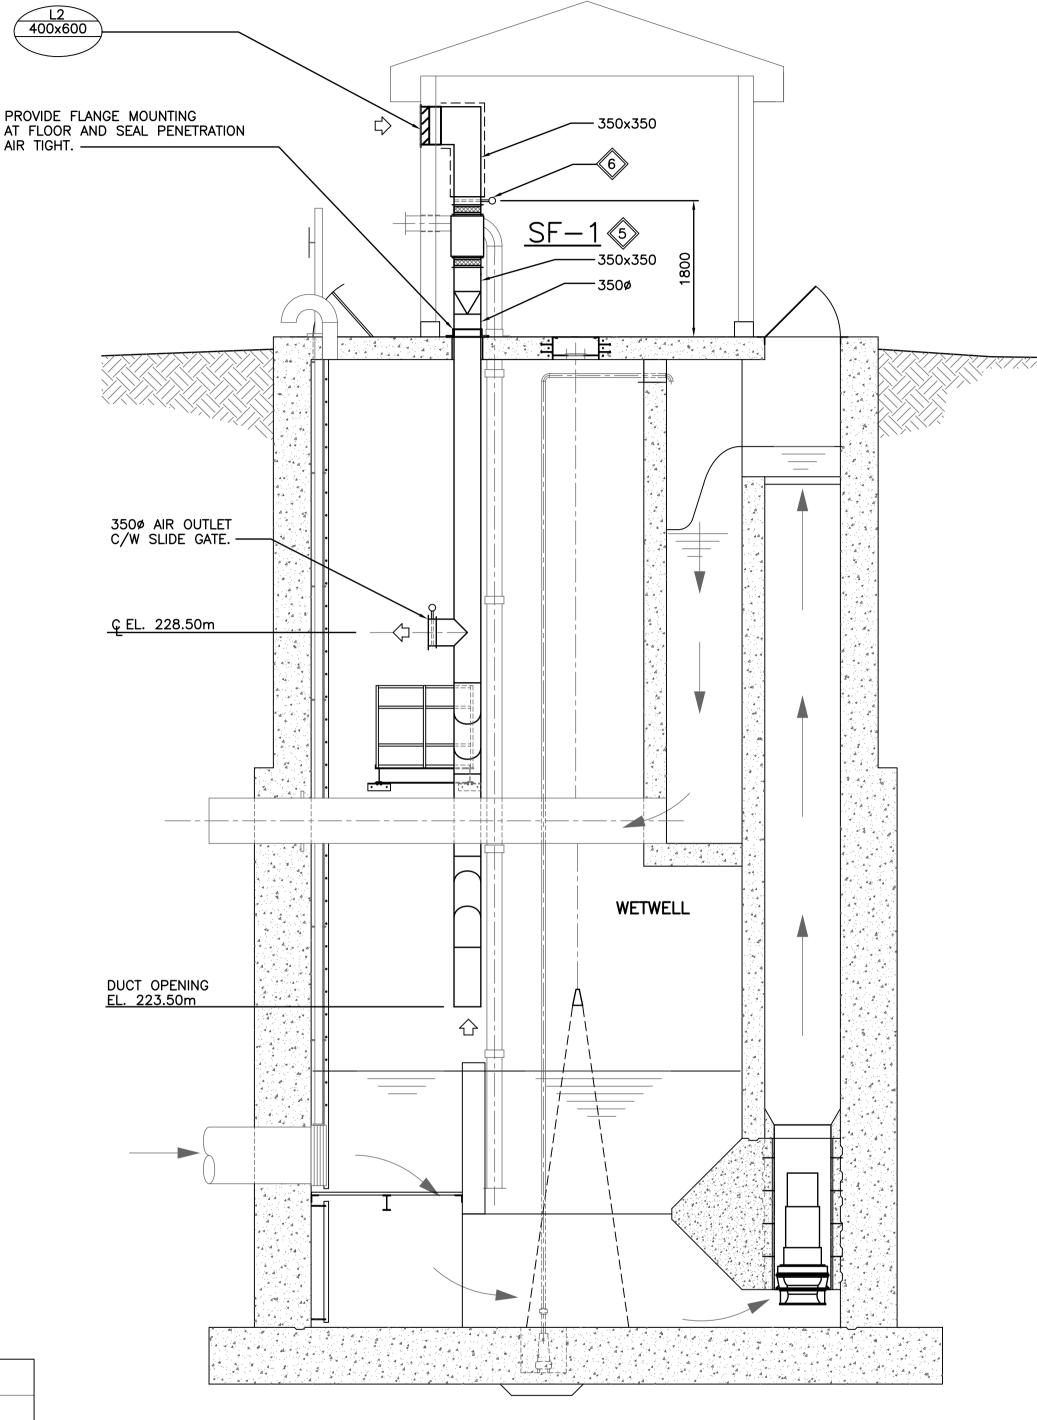



GENERAL NOTES:

- 1. PERFORM WORK IN ACCORDANCE WITH ALL APPLICABLE CODES AND REGULATIONS. 2. REVIEW EQUIPMENT LOCATIONS WITH CONTRACT ADMINISTRATOR PRIOR
- TO INSTALLATION.
- 3. DUCT ROUTING INDICATED ON DRAWINGS ARE APPROXIMATE ONLY, CONFIRM IN FIELD, REROUTE DUCTING TO ELIMINATE FIELD INTERFERENCES WITH BUILDING STRUCTURES, ELECTRICAL ETC. CONFIRM CHANGES WITH CONTRACT ADMINISTRATOR.
- 4. CONFORM TO SMACNA STANDARDS FOR SUPPLY AND INSTALLATION OF DUCTWORK.

KEY NOTES:

- install new exhaust fan $\underline{\text{EF}-1}$ as indicated. Provide spring vibration isolators and flexible duct connections.
- install new unit heaters $\underline{\mathsf{UH}-1}$ as shown. Provide mounting brackets and control wiring (TYP).
- 3 PROVIDE AIR INTAKE AND EXHAUST LOUVERS AS SHOWN (TYP).
- PROVIDE A 25mm THICK INSULATED GALVANIZED STEEL COVERED SLIDING CLOSURE PANEL WITH GASKETTING ON FACE TO SEAL PANEL AGAINST LOUVER FRAME. PROVIDE SLIDING SYSTEM TO SUIT. PROVIDE HANDLES FOR OPENING OF AND CLOSING PANEL. PROVIDE PANEL AND SLIDING SYSTEM SHOP DRAWING FOR REVIEW BEFORE FABRICATION.
- INSTALL NEW SUPPLY FAN SF-1 AS INDICATED. PROVIDE SPRING VIBRATION ISOLATORS AND FLEXIBLE CONNECTIONS. (PROVIDE LAMACOID SIGN ABOVE FAN ON/OFF SWITCH TO READ AS FOLLOWS: "OPEN AIR INTAKE SLIDE GATE BEFORE STÁRTING FAN.")
- PROVIDE A 25mm THICK INSULATED GALVANIZED STEEL COVERED SLIDING CLOSURE PANEL WITH GASKETTING ON FACES.

VENTILATION SYSTEM SEQUENCE OF OPERATION:


THE EXHAUST FAN EF-1 SHALL BE CONTROLLED BY A MANUAL ON/OFF SWITCH, AND A SPACE MOUNTED COOLING THERMOSTAT, AS FOLLOWS;

- EXHAUST FAN <u>EF-1</u> SHALL OPERATE WHEN MANUAL OVERRIDE SWITCH IS ON.
- WHEN MANUAL OVERRIDE SWITCH IS OFF, OPERATION OF <u>EF-1</u> SHALL REFER TO AUTO MODE.
- WHEN IN AUTO MODE EXHAUST FAN $\overline{\text{EF}-1}$ SHALL OPERATE WHENEVER SPACE TEMPERATURE RISES ABOVE SET POINT.
- REFER TO ELECTRICAL FOR CONTROLS DESIGN.

LEGEND:

NEW EQUIPMENT OR DUCTWORK ----- EXTERNALLY INSULATED DUCTWORK ____ THERMOSTAT BACKDRAFT DAMPER C/W ACCESS DOOR 750x250 NECK SIZE EXHAUST FAN UNIT HEATER

CONTROL WIRING

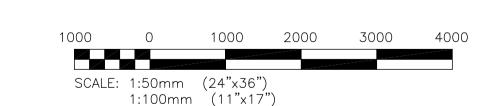

METRIC WHOLE NUMBERS INDICATE MILLIMETRES DECIMALIZED NUMBERS INDICATE METRES


THE CITY OF WINNIPEG TRANSIT DEPARTMENT

OF

C2-B2301-T

APEGN Certificate of Authorization KGS Group No. 245 Date: 25/03/09

LOCATION APPROVED UNDERGROUND STRUCTURES	B.W ELE		DESIGNED BY PSS		
ORIGINAL SIGNED BY DERRICK SAEDAL.					DRAWN BY JHH
SUPV. U/G STRUCTURES DATE COMMITTEE					CHECKED ORIGINAL SIGNED BY R.E. DERKSEN.
NOTE: LOCATION OF UNDERGROUND STRUCTURES AS SHOWN ARE BASED ON THE BEST INFORMATION					APPROVED ORIGINAL SIGNED BY P.S. SILVA.
AVAILABLE. BUT NO GUARANTEE IS GIVEN THAT ALL EXISTING UTILITIES ARE SHOWN OR THAT THE GIVEN LOCATIONS ARE EXACT. CONFIRMATION OF EXISTENCE AND EXACT LOCATION OF ALL SERVICES MUST BE	0	ISSUED FOR TENDER.	25/03/09	PSS	HOR. SCALE VERTICAL
OBTAINED FROM THE INDIVIDUAL UTILITIES BEFORE PROCEEDING WITH CONSTRUCTION.	NO.	REVISIONS	DATE	BY	DATE 08/11/07

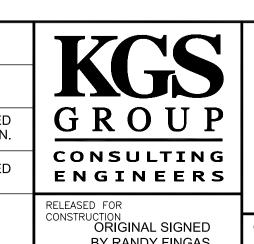

BY RANDY FINGAS.





CONSULTANT PROJECT NO.

08-0163-02

CITY DRAWING NUMBER SOUTHWEST RAPID TRANSIT CORRIDOR - STAGE 1 LD-5324 LAND DRAINAGE PUMPING STATION & ASSOCIATED WORKS 25 25 CONSULTANT DRAWING NUMBER **MECHANICAL**

HEATING AND VENTILATION