


ENLARGED TYPICAL WALL PLAN (2 SEGMENTS 9b TO 17)

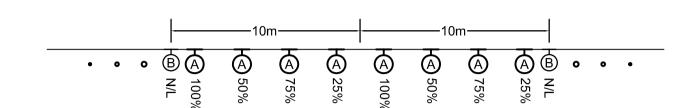

ENLARGED TYPICAL WALL PLAN (2 SEGMENTS 1 TO 9a) SCALE 1:100

	LIGHTING CIRCUIT NUMBERS BY CONTROL TYPE AND SEGMENT #																		
YPE	SEGMENT # (WEST SIDE)																		
11-2	1	2	3	4	5	6	7	8	9a	9b	10a	10b	11	12	13	14	15	16	17
N/L	101	-	101	ı	101	-	101	-	101										
25%	102	102	102	102	102	102	102	102	106	106	106	106	106	106	110	110	110	110	110
50%	103	103	103	103	103	103	103	103	107	107	107	107	107	107	111	111	111	111	111
'5%	104	104	104	104	104	104	104	104	108	108	108	108	108	108	112	112	112	112	112
00%	105	105	105	105	105	105	105	105	109	109	109	109	109	109	113	113	113	113	113
YPE	SEGMENT# (EAST SIDE)																		
IFE	1	2	3	4	5	6	7	8	9a	9b	10a	10b	11	12	13	14	15	16	17
N/L	122	-	122	ı	122	ı	122	ı	122	1	122	1	122	ı	122	-	122	-	122
25%	123	123	123	123	123	123	123	123	127	127	127	127	127	127	131	131	131	131	131

## SYMBOL SCHEDULE

Wall mounted luminaire. 'A' denotes type.


	LUMINA	IRE SCHEDULE				
TYPE	DESCRIPTION	CATALOG NUMBER	LAMPS			
Α	IP66 RATED TUNNEL FLOODLIGHT MOUNTED @ 4.5m A.F.G.	HOLOPHANE TPF 400HP 34 K P 3 G PS	1-400W HPS			
B NIGHT LEVEL WALL PACK C/W QUARTZ RESTRIKE MOUNTED @ 4.0m A.F.G.  HOLOPHANE MW 100HP 34 G PS SPEC 1-100W HPS + 1-250W QZ						
NOTE: REFER TO WRITTEN SPECIFICATIONS FOR FURTHER DETAILS.						

## SPECIFIC ELECTRICAL NOTES

PROVIDE TYPE 'A' LUMINAIRES ALONG TUNNEL WALL AS INDICATED IN ENLARGED TYPICAL WALL PLAN SEGMENT VIEWS DETAIL THIS DRAWING.

WIRE EXTERIOR FIXTURES TO A SEPARATE 20A-1P CIRCUIT. FIXTURES TO BE CONTROLLED TO OPERATE FROM DUSK UNTIL DAWN.


3 PROVIDE ADDITIONAL TYPE 'A' FIXTURES ON APPROACH SIDE. PROVIDE 3 EXTRA FIXTURES IN SEGMENT 17. WIRE TO 50%, 75% AND 100% LIGHTING LEVEL CIRCUITS. PROVIDE 2 EXTRA FIXTURES IN SEGMENT 1. WIRE TO 50% AND 100% LIGHTING LEVEL CIRCUITS.

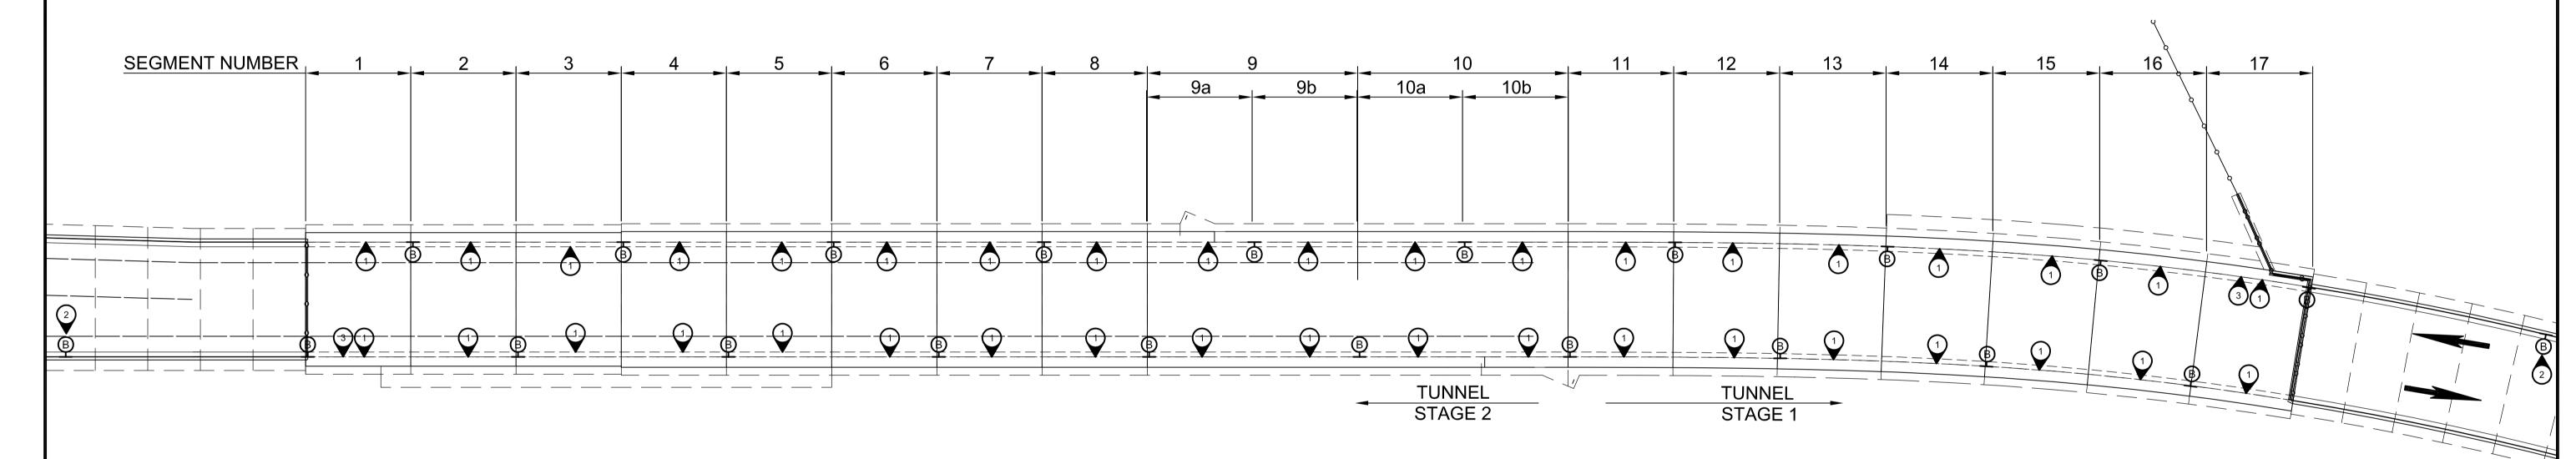



## GENERAL ELECTRICAL NOTES

CAUTION: LONG RUNS. SELECT WIRE SIZE TO LIMIT VOLTAGE DROP TO NO MORE THAN 3% FOR ALL BRANCH CIRCUITS IN ACCORDANCE WITH THE WINNIPEG ELECTRICAL BY-LAWS. PROVIDE WALL MOUNTED W.P. JUNCTION BOXES AS REQUIRED TO ACCOMMODATE.

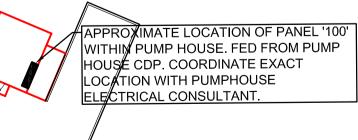


**APEGIN** Certificate of Authorization Nova 3 Engineering Ltd. No. 962 Date: 2009.10.06

REFER TO WWW.NOVA3.CA FOR CAUTIONARY NOTES.

LOCATION	APPROVED
UNDERGROUND	STRUCTURES
SUPV. U/G STRUCTURES COMMITTEE	DATE
NOTE:	
THAT THE GIVEN LOCAL CONFIRMATION OF EXIST	JE BEST INFORMATION JARANTEE IS GIVEN TIES ARE SHOWN OR TIONS ARE EXACT. ITENCE AND EXACT ERVICES MUST BE NDIVIDUAL UTILITIES

APPROVED STRUCTURES	B.M ELE				DESIGNED BY	DZ	
					DRAWN BY	DF	NOVA 3 ENGINEERING I
DATE					CHECKED BY	DZ	CONSULTING ENGINEES  JN: 29-111  TEL.: (204) 943-6142
D STRUCTURES AS					APPROVED BY	VJT	FAX.: (204) 942-1276 201-120 FORT STREET WINNIPEG, MANITOBA
BEST INFORMATION IRANTEE IS GIVEN ES ARE SHOWN OR ONS ARE EXACT. ENCE AND EXACT IVICES MUST BE DIVIDUAL UTILITIES	0	ISSUED FOR TENDER	2009.10.06	DZ	HOR. SCALE	AS NOTED AS NOTED	RELEASED FOR CONSTRUCTION
H CONSTRUCTION.	NO.	REVISIONS	DATE	BY	DATE 2009	9.10.06	DATE

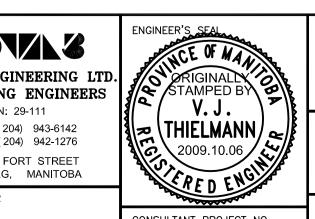

A C.	Winnipeg
	SOUTHWEST

## THE CITY OF WINNIPEG TRANSIT DEPARTMENT

T RAPID TRANSIT CORRIDOR - STAGE 1 TRANSITWAY TUNNEL AT CN RIVERS SUBDIVISION MILEAGE 1.38 & ASSOCIATED WORKS

CITY DRAWING NUMBER U237-09-56 56 73 CONSULTANT DRAWING NUMBER

CONSULTANT PROJECT NO. **ELECTRICAL LAYOUT** 088813

C4-S1200-T