
INTAKE HOODS SERVING NEW BOILERS ABOVE ELECTRICAL CONDUIT 1 COMBUSTION AIR INTAKE

LOCATE COMBUSTION AIR

INSULATED 1000 COMBUSTION 50¢ SANITARY VENT AIR DUCT THROUGH SIDEWALL THROUGH ROOF — TYPICAL OF TWO. —

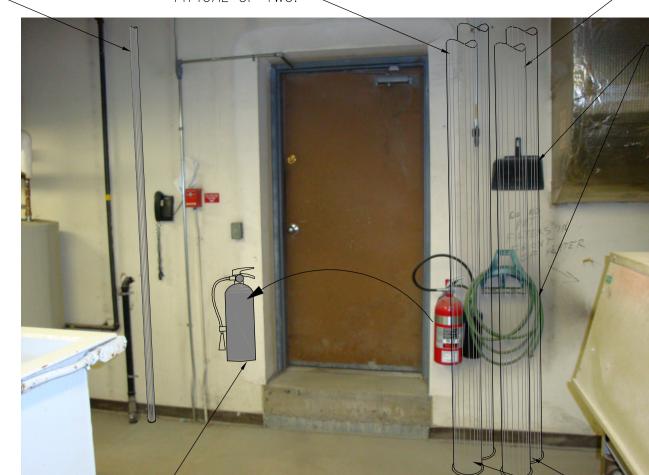

RELOCATE EXISTING

CORE THROUGH CONCRETE FLOOR FOR BOILER

COMBUSTION AND FLUE

VENTING - TYPICAL OF

FOUR.

100¢ FLUE VENT THROUGH

ROOF. TYPICAL OF TWO.


COORDINATE WITH OWNER

NEW LOCATIONS OF OTHER


WALL-MOUNTED EQUIPMENT

REMOVE AND REPLACE DEFECTIVE CHECK VALVE

CHECK VALVE REPLACEMENT

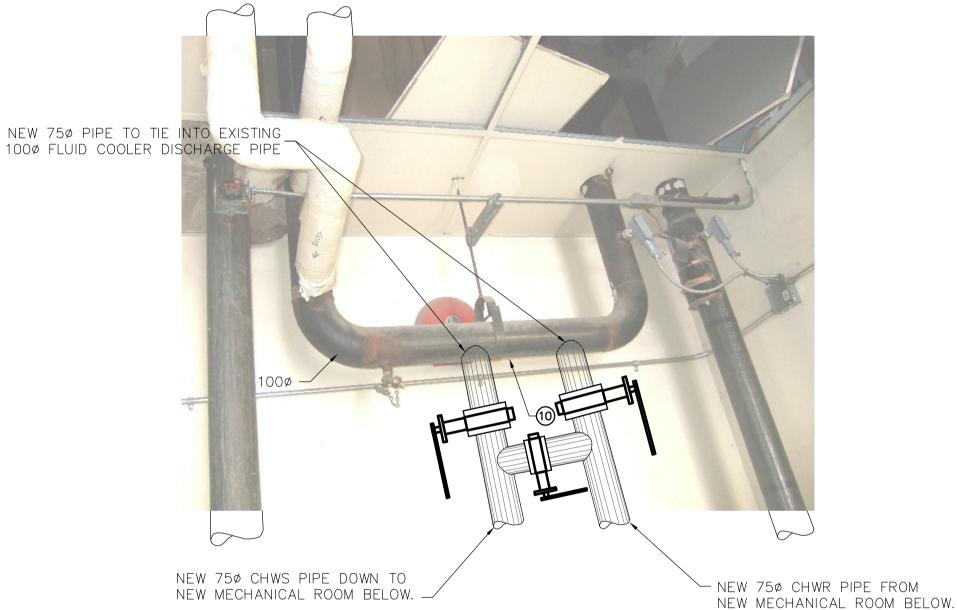

FLUID COOLER PIPE TIE-IN

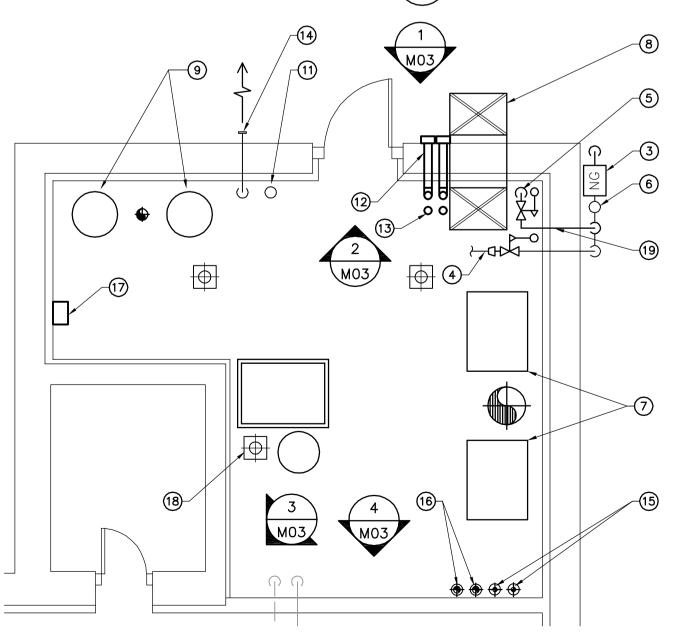

**SEXISTING MECHANICAL ROOM DETAIL** 

GENERAL NOTES

COORDINATE WITH OTHER TRADES SO AS TO PREVENT CONFLICTS.

© 2008 EARTH TECH (CANADA) INC. ALL RIGHTS RESERVED.
THIS DOCUMENT IS PROTECTED BY COPYRIGHT LAW AND MAY NOT BE USED, REPRODUCED OR MODIFIED IN ANY MANNER OR FOR ANY PURPOSE EXCEPT WITH THE WRITTEN PERMISSION OF EARTH TECH (CANADA) INC. DOING BUSINESS AS AECOM ("AECOM") OR A PARTY TO WHICH ITS COPYRIGHT HAS BEEN ASSIGNED. AECOM ACCEPTS NO RESPONSIBILITY, AND DENIES ANY LIABILITY WHATSOEVER, TO ANY PARTY THAT USES, REPRODUCES, MODIFIES, OR RELIES ON THIS DOCUMENT WITHOUT AECOM'S EXPRESS WRITTEN CONSENT.

LAITINEN

Member 25577

**Certificate of Authorization** 

Earth Tech Canada Inc.

No. 730 Expiry: April 30, 2009

CONSTRUCTION NOTES

BALANCING VALVES.

NOTES:

- (1) CAP EXISTING HYDRONIC SUPPLY AND RETURN BRANCHES PREVIOUSLY SERVING HEAT PUMPS. CONNECT NEW HWS AND HWR BRANCHES TO HEAT PUMP c/w NEW FLEXIBLE PIPE CONNECTIONS AND
  - 2 NEW HWS AND HWR BRANCHES RISING FROM BASEMENT BELOW TO HEAT PUMP. SIZE AS SHOWN.
  - 3 NEW GAS METER (5 PSIG) AT GROUND LEVEL. CONNECT NEW & EXISTING GAS PIPING TO NEW METER.
  - 4 EXISTING GAS SERVICE TO EXISTING APPLIANCES IN MECHANICAL ROOM c/w NEW PRESSURE REDUCING STATION. VENT PIPE UP THROUGH ROOF c/w PITCH POCKET.
  - 5 500 NEW GAS BRANCH DOWN TO NEW BOILERS IN MECHANICAL ROOM BELOW c/w PRESSURE REDUCING STATION. VENT PIPE UP THROUGH ROOF c/w PITCH POCKET.
  - 6 EXISTING GAS BRANCH RISING TO EXISTING MAKE-UP AIR UNIT ON MECHANICAL ROOM ROOF.
  - (7) EXISTING BOILERS TO REMAIN.
- (8) EXISTING COMBUSTION AIR DUCT TO REMAIN.
- 9 EXISTING HOT WATER HEATERS TO
- REMAIN. 10 NEW CHWS & CHWR PIPE TO BE WITHIN
- (11) 50¢ SANITARY VENT FROM BASEMENT TO GO THROUGH ROOF OF EXISTING MECHANICAL ROOM.
- 12 INSULATED 1000 COMBUSTION AIR INTAKE.
- 13 100¢ FLUE VENT.

500mm APART.

- 14 EXISTING VENT AT LOW LEVEL.
- 15 NEW 50¢ GWS & GWR PIPE RISING THROUGH MECHANICAL ROOM TO HEATING/COOLING IN EXISTING MAKE-UP AIR UNIT ON ROOF. SEE DWG. MO4.
- (16) NEW 75¢ CHWS & CHWR SERVING EXISTING FLUID COOLER. SEE DETAIL 4/M03 FOR TIE-IN CONNECTION LÓCATION.
- 17) NEW 7.5 HP VFD MOUNTED ON WALL SERVING EXISTING MAKE-UP AIR UNIT ON ROOF.
- 18 SEAL FLOOR AROUND EXISTING FLOOR DRAIN.
- (19) COORDINATE GAS PIPE ROUTING WITH ELECTRICAL PANEL.

ISSUED FOR TENDER REVISION/DESCRIPTION

EARTH TECH | AECOM

DL CHECKED BY PVL APPROVED USER APPROVAL



PLANNING, PROPERTY AND DEVELOPMENT DEPARTMENT CIVIC ACCOMMODATIONS DIVISION 300 - 65 GARRY ST. R3C 4K4


PROJECT **CONFEDERATION BUILDING** 

SUPPLEMENTARY HEATING UPGRADES PHASE 1 - CITY BID OPP. NO. 757-2008

457 MAIN STREET, WINNIPEG, MANITOBA SHEET TITLE

MAIN FLOOR MECHANICAL LAYOUT AND DETAILS

PROJECT NO. SHEET NO. AS SHOWN

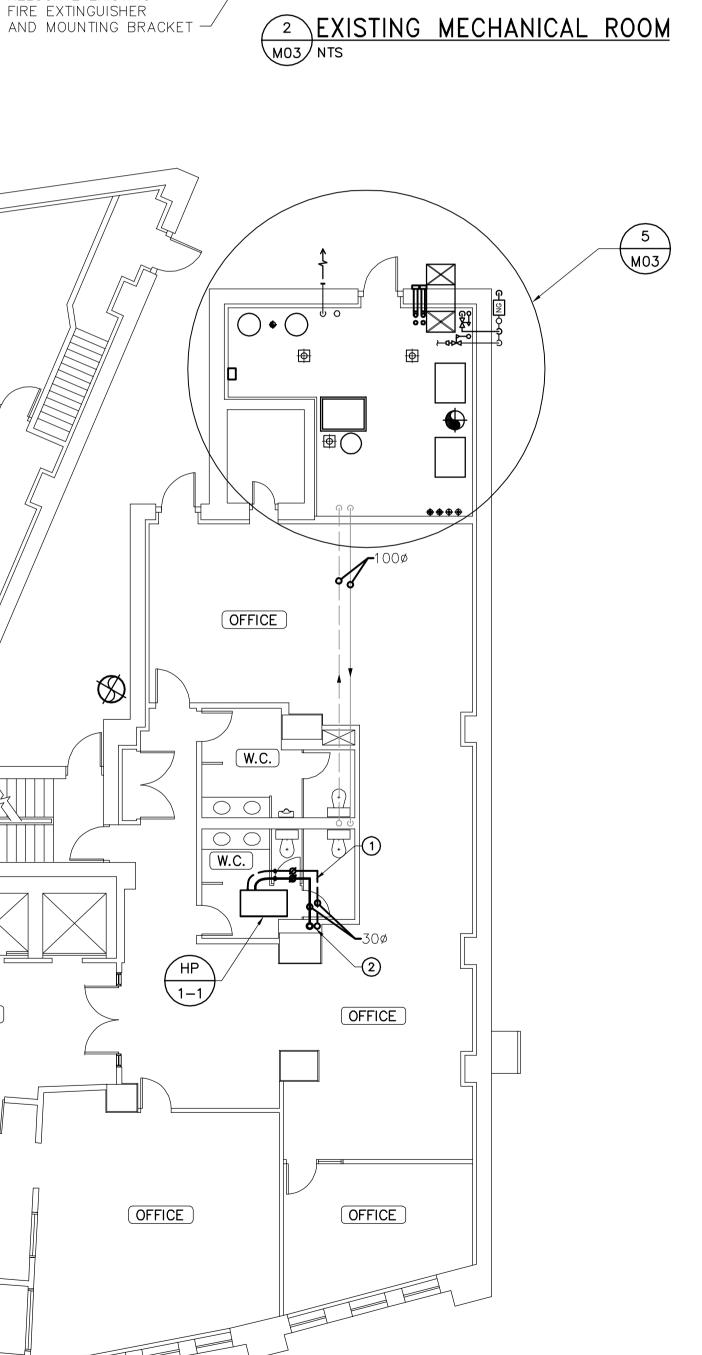

MAIN FLOOR -MECHANICAL PLAN
SCALE: 1:100

OFFICE

LOBBY

DRAWING SHEET SIZE: A1 (841mm x 594mm) PLOT 1:1