SYMBOL LEGEND

CONTRACTOR.

PANELBOARD.

CONTRACTOR.

ALARM HORN.

JUNCTION BOX.


ALARM STROBE LIGHT.

ELECTRIC MOTOR. REFER TO MECHANICAL


DRAWINGS FOR EXACT LOCATION.

DISCONNECT SWITCH BY ELECTRICAL

MAGNETIC STARTER BY ELECTRICAL

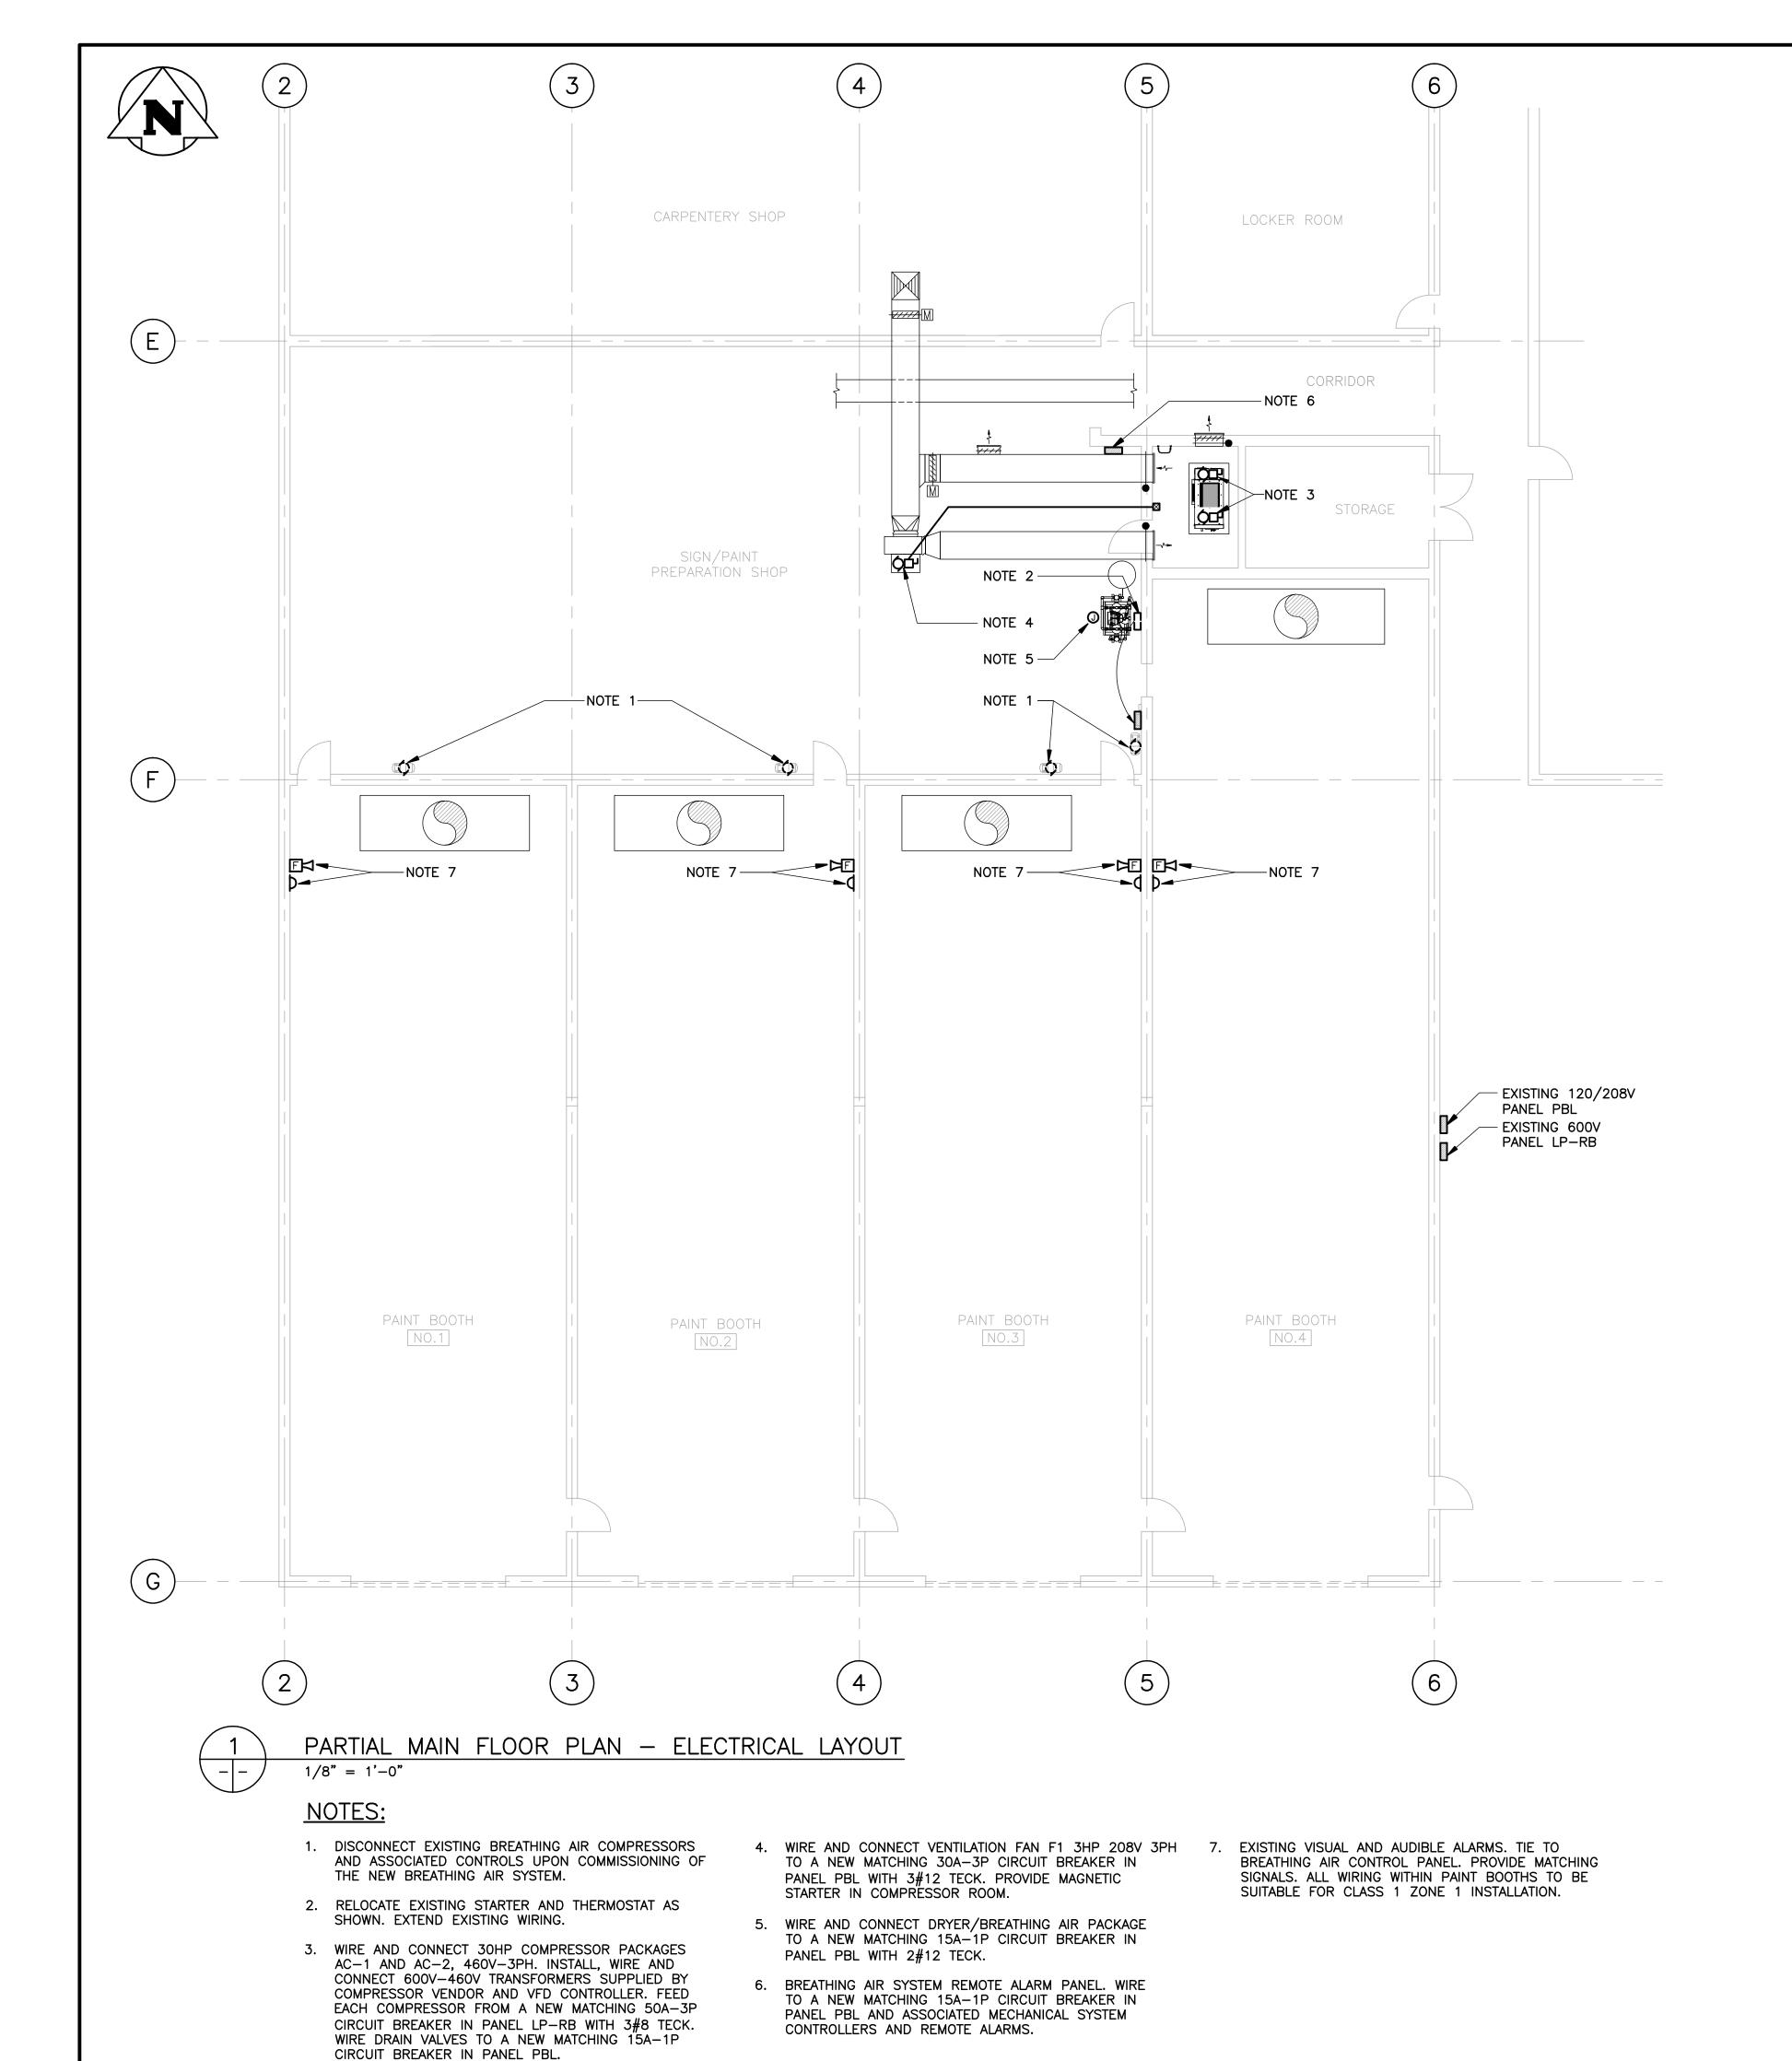


TO VISUAL AND AUDIBLE ALARMS IN EACH PAINT BOOTH TO HIGH AIR PRESSURE TO DRYER/BREATHING SENSOR -AIR PACKAGE TO LOW AIR PRESSURE SENSOR -2 120VAC \bigcirc

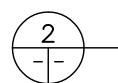

BREATHING AIR ALARM SYSTEM RISER DIAGRAM


NOTES:

- 1. PILOT LIGHTS ON THE ALARM PANEL TO INDICATE LOW AIR PRESSURE, HIGH AIR PRESSURE, AND HIGH CO IN SUPPLY AIR.
- 2. THE FOLLOWING CONDITIONS TO INITIATE AUDIBLE ALARM ON THE PANEL AND AUDIBLE/VISUAL ALARMS IN PAINT BOOTHS: - HIGH AIR PRESSURE
- LOW AIR PRESSURE - HIGH CO IN SUPPLY AIR
- 3. ALARM RESET BUTTON IS TO SILENCE AUDIBLE ALARM ONLY.

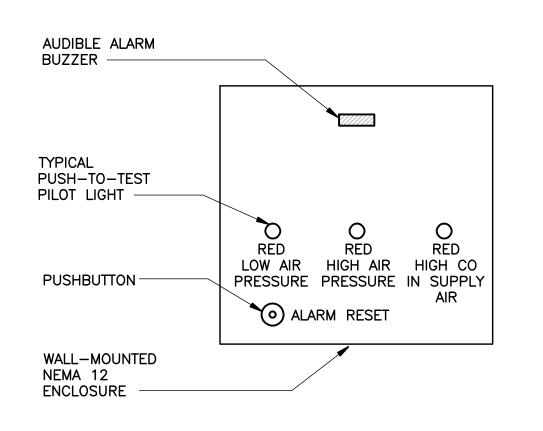



BREATHING AIR ALARM PANEL ELEVATION

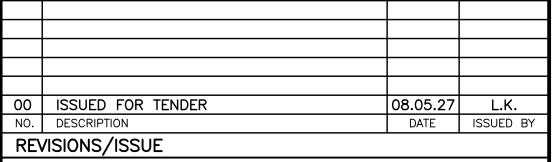

REVISIONS/ISSUE

THE CONTENT OF THIS DOCUMENT IS NOT INTENDED FOR THE USE OF, NOR IS IT INTENDED TO BE RELIED UPON BY ANY PERSON, FIRM OR CORPORATION, OTHER THAN THE CLIENT AND WARDROP ENGINEERING INC. WARDROP ENGINEERING DENIES ANY LIABILITY WHATSOEVER TO OTHER PARTIES FOR DAMAGES OR INJURY SUFFERED BY SUCH THIRD PARTY ARISING FROM USE OF THIS DOCUMENT BY THEM, WITHOUT THE EXPRESS PRIOR WRITTEN AUTHORITY OF WARDROP ENGINEERING AND OUR CLIENT. THIS DOCUMENT IS SUBJECT TO FURTHER RESTRICTIONS IMPOSED BY THE CONTRACT BETWEEN THE CLIENT AND WARDROP ENGINEERING INC. AND THESE PARTIES' PERMISSION MUST BE SOUGHT REGARDING THIS DOCUMENT IN ALL OTHER CIRCUMSTANCES.

CITY OF WINNIPEG TRANSIT DEPARTMENT

WARDROP

Engineering Inc.

WINNIPEG TRANSIT - OSBORNE STREET GARAGE PAINT BOOTH BREATHING AIR SYSTEM UPGRADE

DRAWING DESCRIPTION PARTIAL MAIN FLOOR PLAN ELECTRICAL LAYOUT

PRELIMINARY DRAWING

DESIGNED BY: CHECKED BY: T.S. L.K. APPROVED BY: AR SCALE: AS NOTED 08.04.08 DRAWING NO. 0829720100-DWG-E0001

APEGIN Certificate of Authorization Wardrop Engineering Inc. No. 195 Date: April 30, 2009

1/8"=1'-0"

DM (24" x 36")