


PLAN VIEW

EXTRUDED ALUMINIUM DIVIDER PRECAST CONCRETE SEAT PANEL - CHARCOAL 10ga CUSTOM FORMED STAINLESS STĚEL SEAT PAN CAST ALUMINIUM ENDS -ALUMINIUM BASE PLATE ---


FRONT ELEVATION SCALE 1/8"=1'-0"

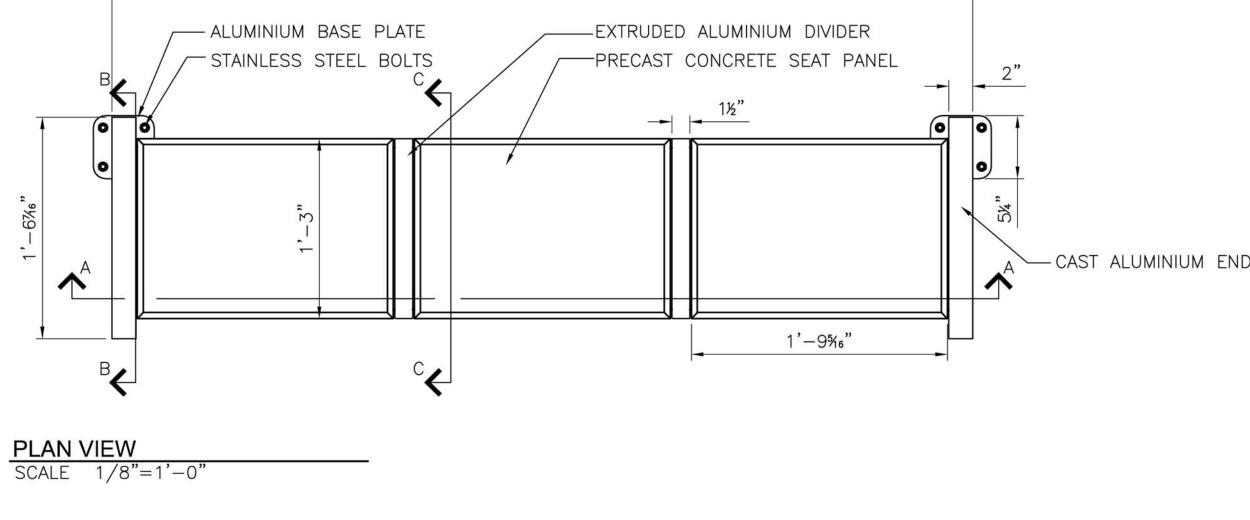

3"x11/2"x15" EXTRUDED ALUMINIUM TUBE DIVIDER WITH CUSTOM CURVED ENDS. PAINTED P211S11 SPARKLE SILVER BY PROTEC $-\frac{1}{6}$ "x1"x1" PLASTIC SPACER STAINLESS STEEL SCREWS WITH PLASTIC 4- STAINLESS STEEL BOLTS INSERT INTO ALUMINIUM DIVIDER 2%" ALUMINIUM BASE PLATE 10ga CUSTOM FORMED STAINLESS STEEL 0 0 SEAT PAN WITH PREDRILLED HOLES FOR DRAINAGE AND BOLTS - STAINLESS STEEL BOLTS **^** CAST ALUMINIUM ENDS -1/6"x1"x1" STAINLESS STEEL SPACER -2½" DIA. DRAIN HOLES LINE OF PRECAST CONCRETE SEAT PANELS ABOVE PLAN OF SEAT PAN AND FASTENINGS

ALL DIMENSIONS PROVIDED FOR INFORMATION ON DESIGN INTENT.

CONTACTOR TO SUPPLY SHOP DRAWINGS STAMPED BY A STRUCTURAL ENGINEER LICENSED TO PRACTICE IN THE PROVINCE OF MANITOBA WITH EXTENSIVE EXPERIENCE IN THE DESIGN & MANUFACTURING OF ALUMINIUM SITE FURNITURE. SHOP DRAWINGS TO INCLUDED WALL THICKNESSES, MATERIALS ETC. AS LISTED IN THE SPECIFICATIONS.

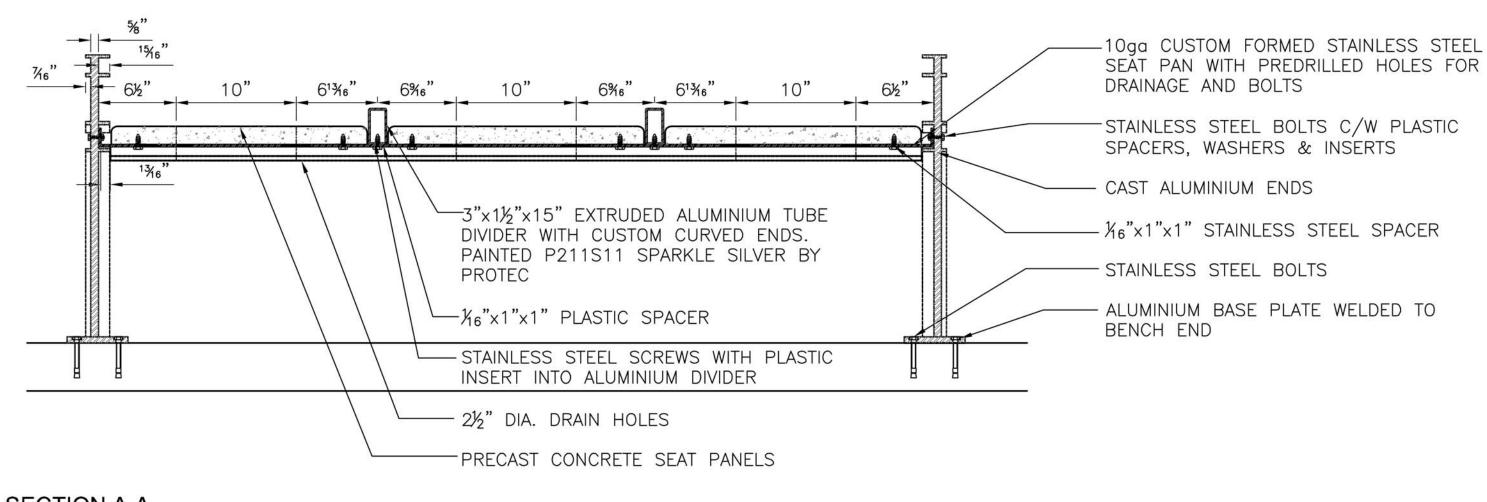



SECTION C-C

SCALE 1/4"=1'-0"


SECTION A-A SCALE 1/8"=1'-0"


SCALE 1/8"=1'-0"

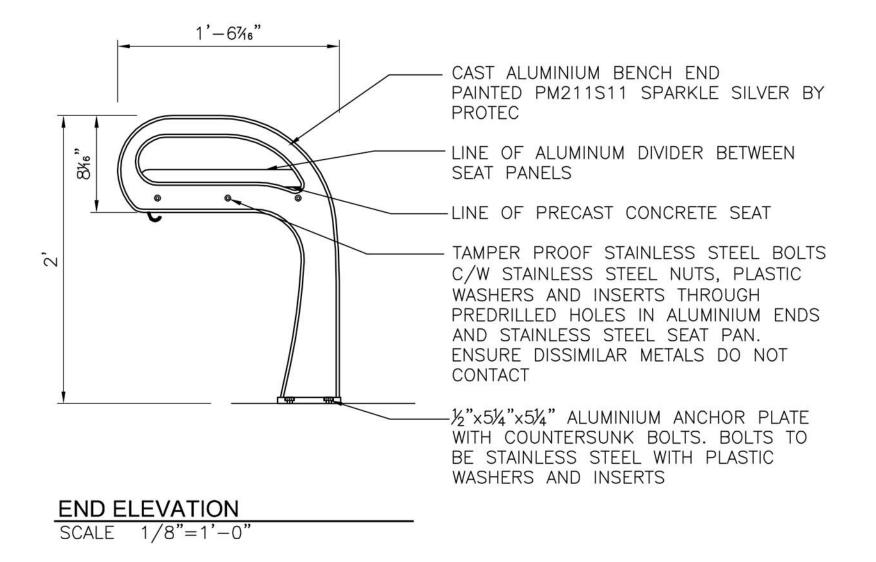

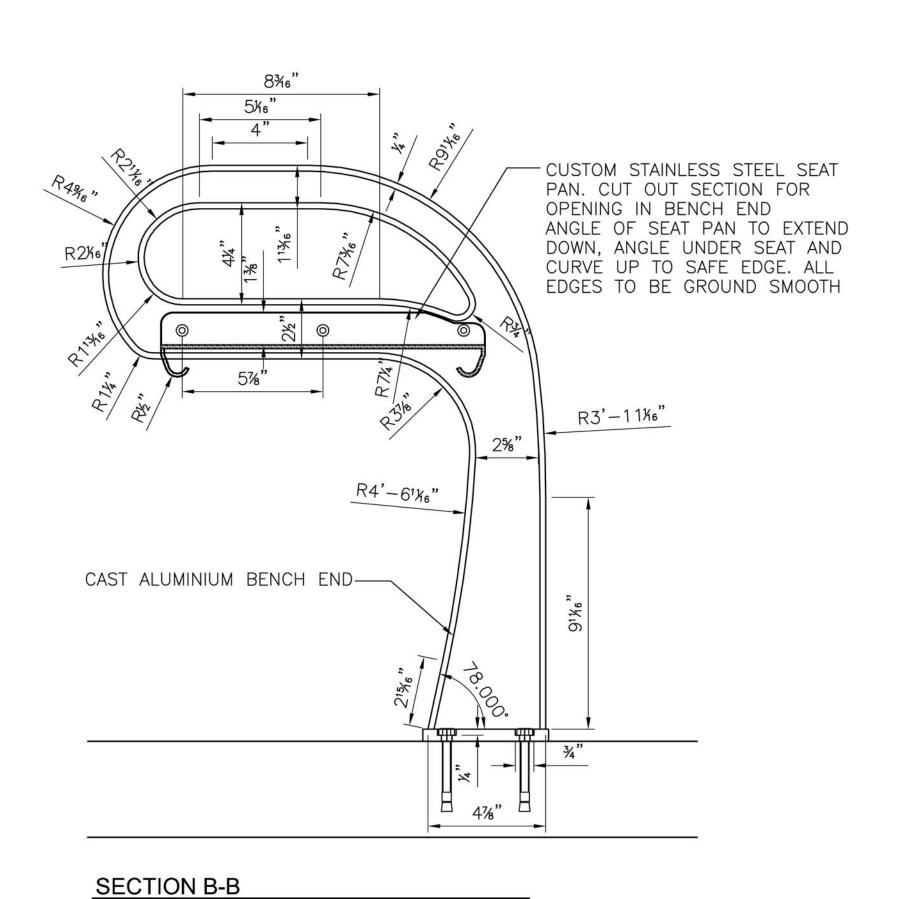

SCALE 1/4"=1'-0"

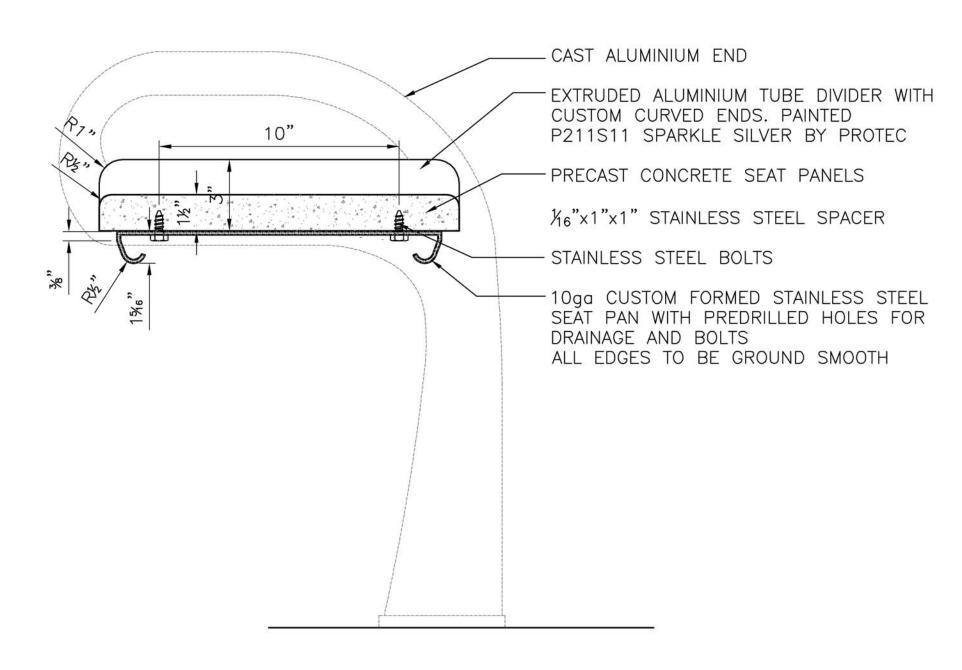

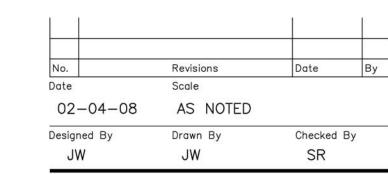



WINNIPEG TRANSIT

Project Title

SUPPLY & INSTALLATION OF BENCHES FOR WINNIPEG TRANSIT - PHASE 2

Sheet Title **BACKLESS BENCH DETAILS**

B2 Project No. 06-029

FILE: B1-BACKLESS BENCH.dwg