
# SOUTH TRANSCONA COMMUNITY CLUB EXTERIOR WALL UPGRADES

24 BORDEN AVENUE. WINNIPEG. MANITOBA

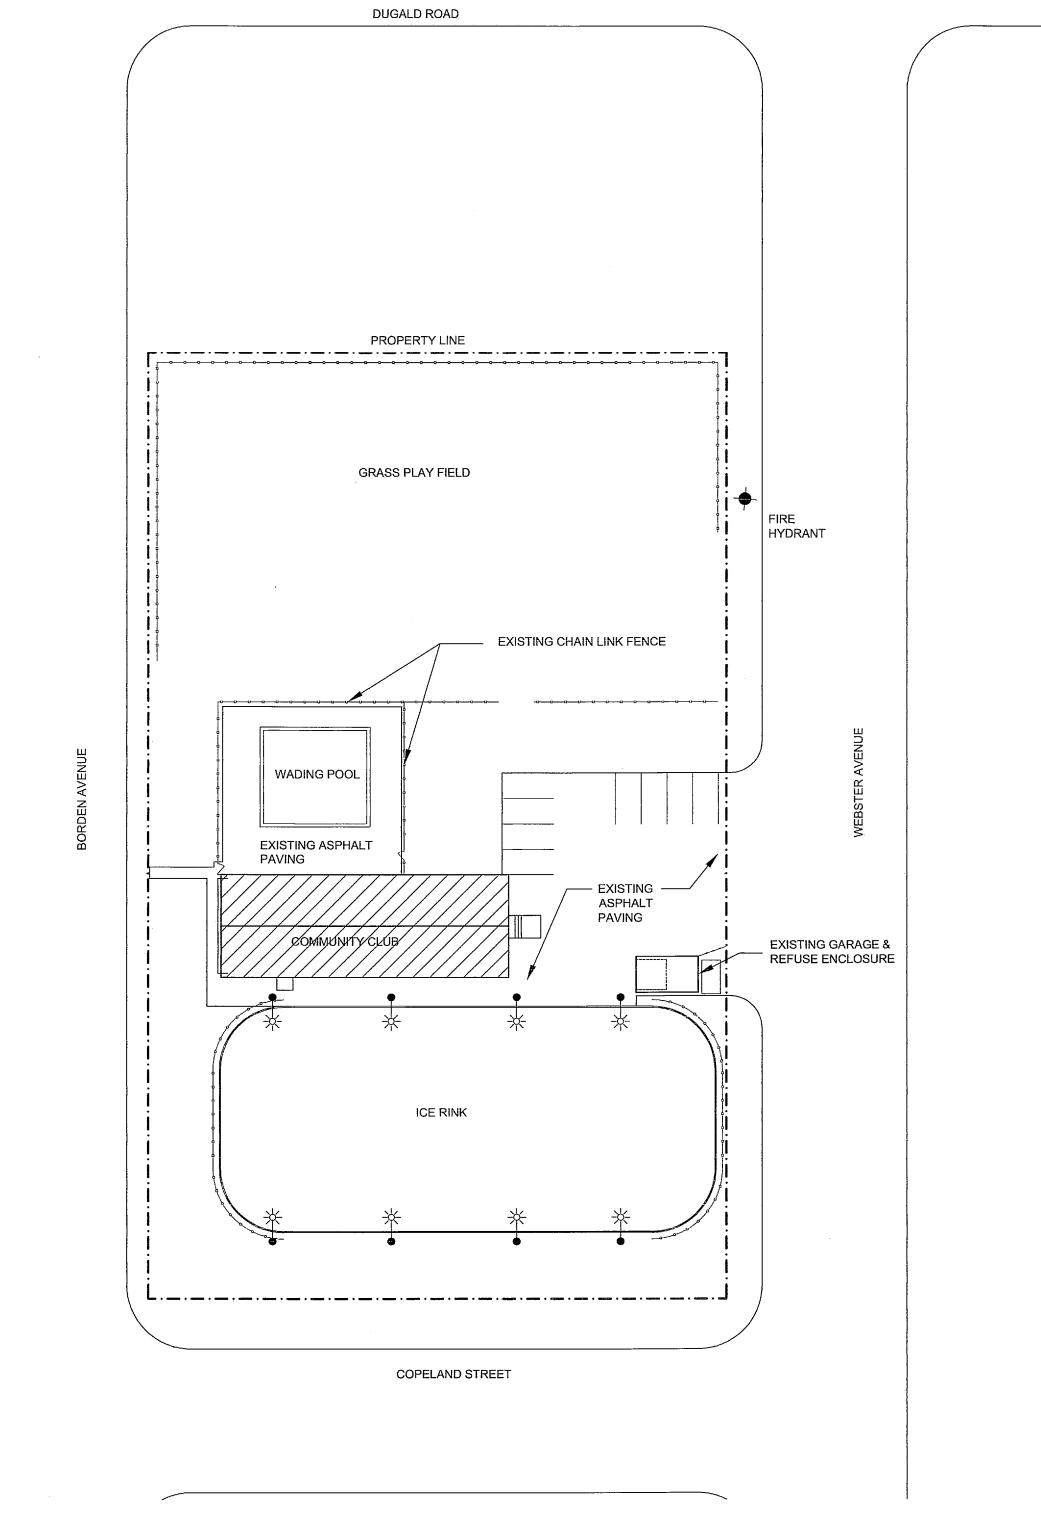

Site Plan
Scale N.T.S.

**DRAWING LIST** 

ARCHITECTURAL

A-0 SITE PLAN & PROJECT DATA A-1 DEMOLITION FLOOR PLAN & ELEVATIONS A-2 RENOVATION FLOOR PLAN & ELEVATIONS

A-3 WALL SECTIONS & DETAILS A-4 DETAILS A-5 SPECIFICATIONS

SUPPLEMENTAL

SK-1 BUILDING PLAN SK-2 ELEVATIONS

SK-3 ELEVATIONS

# **PROJECT DATA**

#### PROJECT INFORMATION

Civil Address:

Owner:

Building Area:

Construction:

### **BUILDING CODE REVIEW**

A2 Assembly Occupancy Classification:

3.2.2.28 One Storey facing 3 streets Conforming Construction:

# **GENERAL NOTES**

1. The Contractor shall review all drawings before commencing the Work and report any discrepencies to the Contract Administrator.

124 Borden Avenue

2800 s.f. (260 s.m)

City of Winnipeg

Concrete Block

- 2. Building dimensions are for reference only. Existing dimensions are to be site verified before beginning construction. Report discrepencies to the Contract Administrator before proceeding.
- All inconsistencies and errors shall be promptly reported to the Contract Administrator for correction prior to continuation of work.
- 4. The Contractor shall schedule and coordinate all work between Subcontractors and specialty items.
- 5. It is the responsibility of the Contractor and Subcontractors to install all products according to the manufacturer's instructions. Failure to do so can result in reinstallation of such at no extra cost to the City.
- The Contract Administrator will assist in all matters requiring clarification, interpretation, or additional details when necessary during the Contract.

THIN BRICK VENEER GROUTED AND BEDDED IN MORTAR OVER TWO COATS OF LATEX ADMIX AND GALVANIZED WIRE MESH MECHANICALLY FASTENED TO 1/2" T&G PLYWOOD MECHANICALLY FASTENED AND GLUED WITH EDGES SECURED TO VERTICAL GALVANIZED Z-GIRTS @24" o/c

3" RIGID INSULATION (R15) AIR / VAPOUR BARRIER, APPLIED TO CLEANED AND REPAIRED EXISTING 8" CONCRETE BLOCK C/W LOOSE FILL VERMICULITE INSULATION

1X4 WOOD STRAPPING ON GALVANIZED Z-GIRTS @ 24" o/c 3" RIGID INSULATION (R15) AIR / VAPOUR BARRIER APPLIED TO CLEANED AND REPAIRED EXISTING 8" CONCRETE BLOCK C/W LOOSE FILL VERMICULITE INSULATION

# **WALL TYPES**

SYMBOL LEGEND

DRAWING NOTE

--- REMOVE OBJECTS

LIGHT STANDARD

---- CHAIN LINK FENCING

WALL TYPES

**DESCRIPTION OF WORK** 

Exterior wall upgrades.

screens, etc.)

EXISTING WALL CONSTRUCTION

The major components of the Work are as follows:

thermally broken aluminum framing system.

Structural Repairs to existing masonry walls.

Replace existing window units with hermetically sealed double glazed in

Miscellaneous specialty items (i.e. lighting, relocate A/C units, wire mesh

PAINTED FIBRE REINFORCED CEMENTITIOUS PANELS

**BID OPPORTUNITY NO. 11-2008** PROJECT TITLE

#### **SOUTH TRANSCONA** COMMUNITY CLUB EXTERIOR WALL UPGRADES

124 BORDEN AVENUE

SITE PLAN & PROJECT DATA

DRAWING TITLE

Ownership of Documents:

1. TENDER

ISSUED FOR

ARCHITECT / PRIME CONSULTANT

INTERIOR DESIGN

ENGINEERING CONSULTANT

ENGINEERING CONSULTANT

SYNYSHYN ARCHITECTURE ARCHITECTURE PLANNING

FACILITY MANAGEMENT

PRESENTATIONS

603-63 ALBERT STREET WINNIPEG NANITOBA CANADA R3B 1G4

TELEPHONE 947-1100 FACSIMILE 956-5742

**JANUARY 18, 2008** 

Drawings and specifications as instruments of service are and shall remain the property of the Architect whether the project for which they are made is executed or not. They are not t

be used by the owner on other projects or extensions to this project except by agreement in writing and with appropriate

This drawing shall not be scaled. Follow given dimensions only

ALL DIMENSIONS ARE APPROXIMATE

DRAWN BY AD, JK

DRAWING No. A-O


ISSUE DATE 01/18/2008


PROJECT No. 681

**WIRE MESH PANEL TYPES** 


WM 1

**WINDOW TYPES** 

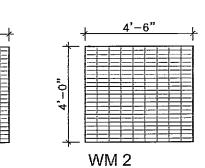

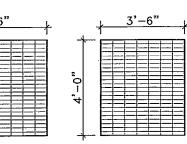

6'-0"

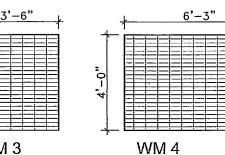

4'-0"

WC

