
NOTES:

1. THRIE BEAM AND W BEAM SECTIONS SHALL BE JOINED SO THAT THE SPLICES ARE LAPPED TO FLOW WITH THE DIRECTION OF TRAFFIC.


2. FOR GUARDRAIL DETAILS AND BILL OF MATERIAL SEE WN—S0477.

3. READ THIS SHEET IN CONJUNCTION WITH THE STANDARD 98PL2

- RAIL SYSTEM.
- 4. NESTED THRIE BEAM IS TWO SECTIONS OF GUARDRAIL, ONE SET INSIDE THE
- 5. POST OFFSET DIMENSIONS SHOWN ARE FROM INSIDE FACE OF CURB. 6. ALL NAILS TO BE GALVANIZED.
- 7. ALL SPLICE BOLTS AND HEX. BOLTS (EXCLUDING POST BOLTS) TO BE TORQUED
- 8. SEE MTGS GUARDRAIL/POST STANDARD DRAWINGS AT: www.gov.mb.ca\tgs\TrafEng\Guardrail.html

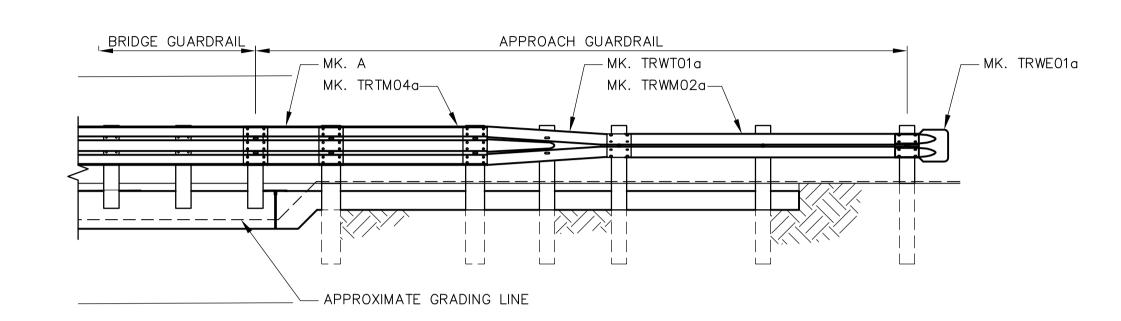

WEST ELEVATION SCALE 1:50

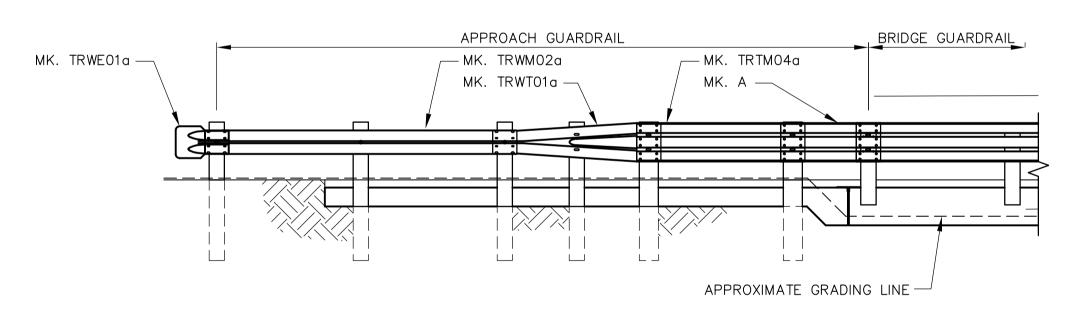

EAST ELEVATION SCALE 1:50

NORTH APPROACH GUARDRAIL PLAN SCALE 1:50

		B.M. ELEV.					CH2MHILL		CauthTach	ENGINEER'S SEAL	THE CITY OF WINNIPEG
	EAPEGN					Frederickson Cooper ARCHITECTS		Earth Tech A Tyco International Ltd. Company		ORIGINAL SIGNED BY	Winnipeg WATER AND WASTE DEPARTMENT ENGINEERING DIVISION
	Certificate of Authorization Earth Tech Canada Inc.					DESIGNED BY	AP/JC	CHECKED J.N. CRANG	WATER TREATMENT PLANT CITY FILE NUMBER		
						DRAWN BY	KC	APPROVE BY	ED DT	07/11/09	CONSTRUCTION OF ROADS AND LANDSCAPING sheet of
ا	No. 730					SCALE:	AS NOTED	RELEASE CONSTRU	RUCTION BY:	CONSULTANT DRAWING NO. WN-S0476	STRUCTURAL CITY DRAWING NUMBER
		00 NO.	ISSUED FOR TENDER REVISIONS	07/11/09 DATE	/11/09 PAAP DATE BY	DATE	07/02/14	R. SOROKOWSK DATE 07/11/09	WESTERN BRIDGE APPROACH GUARDRAIL LAYOUT AND DETAILS 1-0601N-A-S0476-001-00D		