ASHRAE 62.1 VENTILATION SUMMARY

UNIT	OCCUPANCY CATEGORY	PEOPLE OUTDOOR AIR RATE CFM (L/S) / OCCUPANT	NUMBER OF OCCUPANTS		AREA OF SPACE SQ. FT.	AREA OUTDOOR AIR RATE CFM (L/S) / SQ. FT.	**OCCUPIED MIN. O/A CFM (L/S)	***COMBINED OUTDOOR AIR CFM (L/S)
	ASSEMBLY	5 CFM (2) / OCCUPANT	80	400 CFM (189 L/S)	1566	0.06 CFM (.03) / SQ. FT.	94 CFM (45 L/S)	494 CFM (233 L/S)
F-1	ASSEMBLY	5 CFM (2) / OCCUPANT	25	125 CFM (59 L/S)	570	0.06 CFM (.03) / SQ. FT.	34 CFM (16 L/S)	159 CFM (75 L/S)
٠	COMPUTER LAB	10 CFM (2) / OCCUPANT	8	80 CFM (37 L/S)	386	0.12 CFM (.06) / SQ. FT.	46 CFM (22 L/S)	126 CFM (59 L/S)
	CAFETERIA	7.5 CFM (3.5) / OCCUPANT	2	15 CFM (7 L/S)	644	0.18 CFM (.08) / SQ. FT.	116 CFM (55 L/S)	131 CFM (62 L/S)
TOTAL	/////						290 CFM (137 L/S)	910 CFM (430 L/S)
	ASSEMBLY	5 CFM (2) / OCCUPANT	50	250 CFM (118 L/S)	865	0.06 CFM (.03) / SQ. FT.	52 CFM (25 L/S)	302 CFM (142 L/S)
F-2	OFFICE	5 CFM (2) / OCCUPANT	2	10 CFM (5 L/S)	219	0.06 CFM (.03) / SQ. FT.	13 CFM (6 L/S)	23 CFM (11 L/S)
TOTAL							181 CFM (85 L/S)	456 CFM (215 L/S)
AHU-1	AUDITORIUM	5 CFM (2) / OCCUPANT	400	2000 CFM (944 L/S)	5109	0.06 CFM (.03) / SQ. FT.	307 CFM (145 L/S)	2307 CFM (1088 L/S)
TOTAL	1////			////////			307 CFM (145 L/S)	2307 CFM (1088 L/S)

NOTES: *OCCUPANT LOADS BASED ON ASHRAE STANDARD 62.1-2004, VENTILATION FOR ACCEPTABLE INDOOR AIR QUALITY.

**THIS COLUMN INDICATES MINIMUM VENTILATION AIR VOLUME IF OUTSIDE AIR DAMPER IS CONTROLLED BY A CO2 SENSOR.

***INFORMATION PROVIDED FOR REFERENCE ONLY.

DIFFUSER/GRILLE/LOUVRE SCHEDULE:

TYPE	MAKE	MODEL	SERVICE	DESCRIPTION
Α	PRICE	LBP	SUPPLY	SURFACE MOUNTED, LBP15A/1000/B12, SIZES ON DRAWINGS
В	PRICE	SERIES 80	TRANSFER/EXHAUST/RETURN	SURFACE MOUNTED, 80/F/A/B12, SIZES ON DRAWINGS
С	PRICE	ATGH	TRANSFER	DOOR MOUNTED, ATGH/BF/B15, SIZES ON DRAWINGS
D	PRICE	520	SUPPLY	DUCT MOUNTED, 520/F/L/A/B12, SIZES ON DRAWINGS
Ε	PRICE	SCD	SUPPLY	SURFACE MOUNTED, SCD/3/31/B12, SIZES ON DRAWINGS
F	PRICE	520	SUPPLY	SURFACE MOUNTED, 520/F/L/A/B12, SIZES ON DRAWINGS
G	PRICE	530	EXHAUST	SURFACE MOUNTED, 530/F/L/A/B12, SIZES ON DRAWNGS
Н	PRICE	96	RETURN	SURFACE MOUNTED, 96/L/A/B12, SIZES ON DRAWNGS

* ALL DIFFUSERS INSTALLED IN DRYWAL CEILINGS TO HAVE INTEGRAL DAMPERS. REFER TO ARCHITECTURAL FOR FINAL CEILING TYPES

CONDENSING UNIT SCHEDULE

NO. MAKE		MODEL	REFRIG. CAPACITY KW	МО	MP. TOR CH)	MO	ND. TOR (CH)	SUPPLY PROVIDED BY DIV.	INSTALLED BY DIV.	WRED BY DIV.	REFRIGERANT TYPE
			(MBH)	RLA	LRA	FLA	LRA				
CU-1 & CU-1B	LENNOX	13ACO-036	21 (72)	14.4	77.0	1.0	1.9	15	15	16	R-22
CU-2 & CU-2B	LENNOX	13AC0-036	21 (72)	14.4	77.0	1.0	1.9	15	15	16	R-22

* COORDINATE ALL VOLTAGES WITH DIVISION 16 * CU-1 & CU-1B TO BE ENGAGED SIMULTANEOUSLY * CU-2 & CU-2B TO BE ENGAGED SIMULTANEOUSLY

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<u>FURNAC</u>	E SCHEDULE												
NO.	LOCATION	MAKE	MODEL	AIR I/s (CFM)	EXT. STATIC PRESSURE PA (IN)	MOTOR KW (HP)	FILTER THICKNESS MM (IN)	HEAT CAPACITY KW (MBH)	HEATING MEDIUM	COOL CAPACITY KW (MBH)	SUPPLY PROVIDED BY DIV.	INSTALLED BY DIV.	BY DI
F-1	BASEMENT MECH. ROOM	LENNOX	G24M4/6	1130 (2400)	49.8 (.20)	.55 (3/4)	25 (1")	29 (100)	NATURAL GAS	21 (72)	15	15	16
F-2	BASEMENT MECH. ROOM	LENNOX	G24M4/6	1130 (2400)	49.8 (.20)	.55 (3/4)	25 (1")	29 (100)	NATURAL GAS	21 (72)	15	15	16

* UNIT TO HAVE SPARE SET OF FILTERS * UNIT TO HAVE SIDEWALL RETURN OPTION C/W ECONOMIZER LENNOX MODEL #EMD14M-65 AND CONTROLS PACKAGE.

* COORDINATE ALL VOLTAGES WITH DIVISION 16 * C/W CO2 SENSOR * C/W STAINLESS STEEL HEAT EXCHANGER

AIR HANDLING UNIT SCHEDULE

NO.	MAKE	MODEL	AIR L/S (CFM)	EXT. STATIC PRESSURE PA (IN)	MOTOR KW (HP)	FILTER THICKNESS MM (IN)	HEATING COIL (Y/N)	HEATING MEDIUM		COOLING CAPACITY KW (MBH)	TURN DOWN RATIO	ECONOMIZER	REFRIGERANT TYPE	UNIT ACCESSORIES
AHU-1	ENGINEERED AIR	FWB182	3394 (7200)	124.5 (.5)	5.59 (7.5)	50 (2*)	Y	NATURAL GAS	132 (450)	63 (216)	15:1	YES	R-22	HOUSEKEEPING PAD & STAND BY STRUCTURAL

* COORDINATE ALL VOLTAGES WITH DIVISION 16 * C/W CO2 SENSOR * REFER TO SEQUENCE OF OPERATIONS IN SPEC FOR CONTROL * C/W STAINLESS STEEL HEAT EXCHANGER


FAN SCHEDULE

NO.	LOCATION	MAKE	MODEL	AIR L/S (CFM) 70°F	STATIC PA (IN H20)	MOTOR HP (kw)	REMARKS
EF-1	ATTIC SPACE	GREENHECK	CSP-A290	203 (430)	124.5 (0.5)	FRAC	C/W 1 HR ROTARY DIAL TIMER SUPPLIED AND INSTALLED BY DIVISION 16
EF-2	ATTIC SPACE	GREENHECK	CSP-A780	248 (525)	124.5 (0.5)	FRAC	C/W 24 HR/ 7 DAY PROGRAMMABLE TIMER SUPPLIED AND INSTALLED BY DIVISION 16
EF-3	CRAWLSPACE	GREENHECK	CSP-B150	35 (75)	124.5 (0.5)	FRAC	C/W HUMIDISTAT CONTROL
CF-1	GYM	CANARM	CP-36	_	_	FRAC	C/W VARIABLE SPEED SWITCH MC-3 SUPPLIED BY DIV. 15 & INSTALLED BY DIV. 16


PUMP SCHEDULE

PUMP :	SCHEDULE		a.							
NO.	SERVICE	LOCATION	MAKE	MODEL	SIZE MM (IN)	CAPACITY L/S (GPM)	HEAD M (FT.)	MOTOR KW (HP)	SPEED RPM	REMARK
P-1	WADING POOL	PUMP HOUSE	ARMSTRONG	4300	38ø (2*)	10 (160)	9.75 (32)	2.2	1800	BRONZE FITTED
P-2	WEEPING TILE	CRAWLSPACE	BARNES	BP-314	50ø (2*)	1.58 (25)	8 (25)	.25 (1/3)	1750	C/W FLOAT ARM
P-3	RECIRC.	MECH. ROOM	ARMSTRONG	ASTRO 50B	-	0.63 (10)	4 (13)	FRAC.	3000	REFER TO DRAING FOR LOCATION
P-4	PUMPED CONDENSATE	SEE DRAWING	LITTLE GIANT	EC-250	_	0.125 (2)	0.6	FRAC.	-	REFER TO DRAING FOR LOCATION

* COORDINATE ALL VOLTAGES WITH DIVISION 1

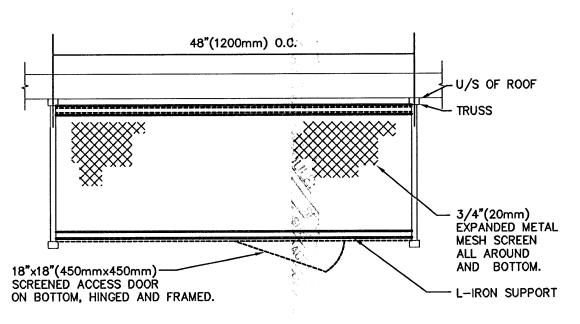




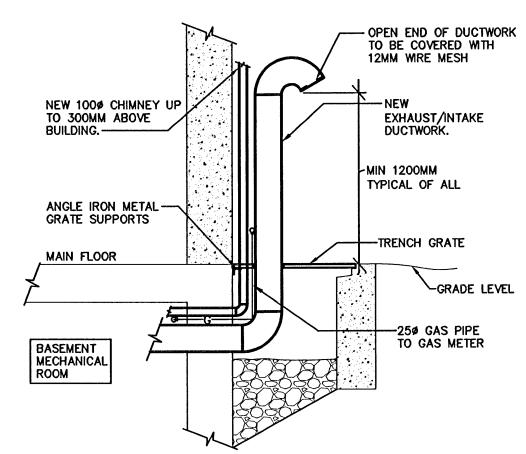


1 BASEMENT MECHANICAL DUCTWORK DETAIL


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3 VAV BOX DETAIL

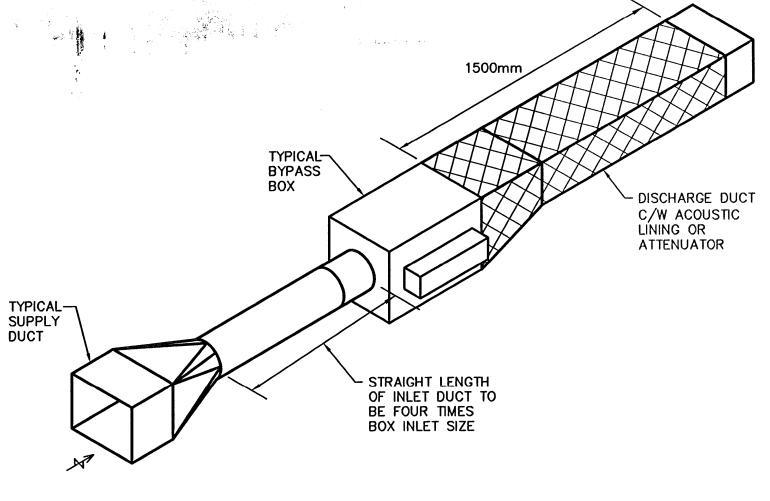
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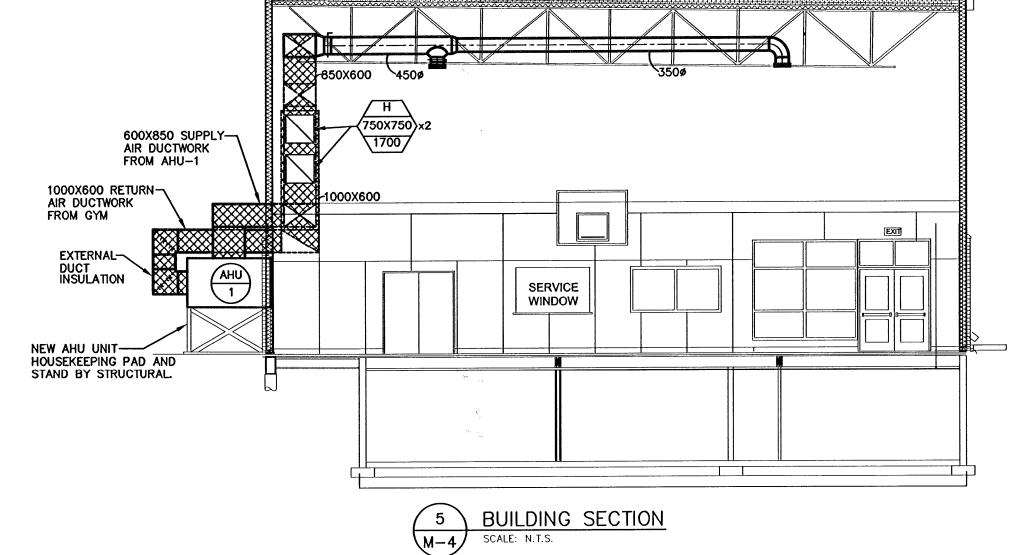





TRANSFER AIR DETAIL

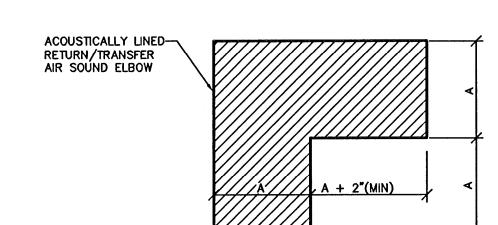
SCALE: N.T.S.

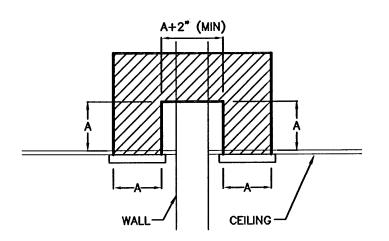

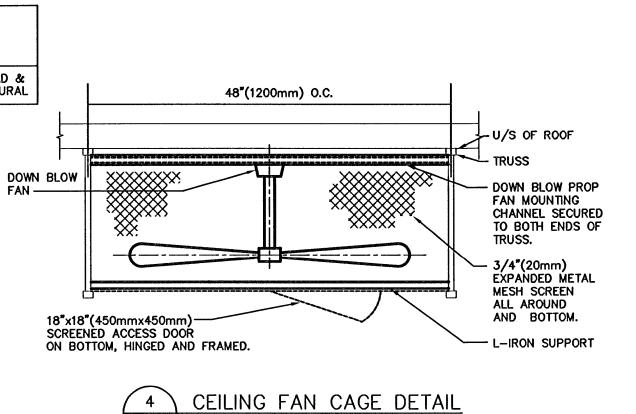

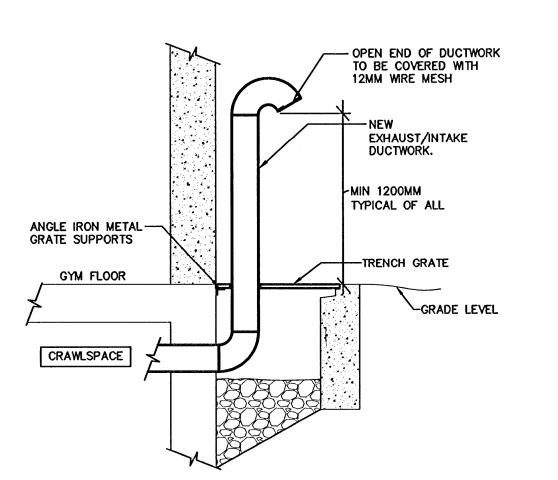

7 CRAWLSPACE VENTILATION DETAIL
SCALE: N.T.S.

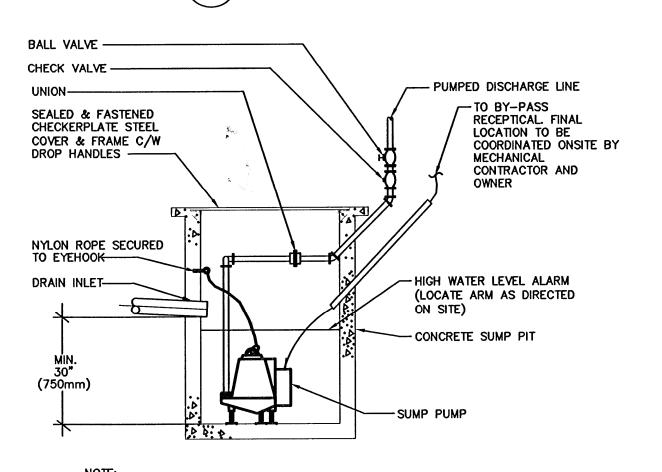

NOTE:
SUMP TO BE MINIMUM 750x750mm SQUARE OR 750mm DIAMETER.

8 WEEPING TILE PIT DETAIL
M-4 SCALE: N.T.S.

This drawing must not be scaled.

The general Contractor must verify all

The general Contractor must verify all dimensions datums and levels prior to commencement of wor All errors and omissions must be reported immediately to the Architect.

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No. 589 Expiry: April 30, 2008

engine



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VALOUR COMMUNITY CENTRE GYMNASIUM ADDITION AND REVOVATIONS

715 Telfer St. North, Winnipeg, Manitoba

sheet title

MECHANICAL SPECIFICATION

AND DETAILS

project no. 5603
scale :AS SHOWN
drawn by: RK
approved by: SR

date July 6, 2007

sheet no.