

NEMA 1 PUMPING STATION DUPLEX PUMP CONTROLLER (IN WEATHERPROOF NEMA 4 ENCLOSURE). PRODUCT SHALL BE GOULDS SES SERIES CONTROLLER OR APPROVED EQUAL. CONTROLLER SHALL BE COMPLETE WITH 2 HOA SWITCHES, RED ALARM LIGHT, REMOTE ALARM CONTACTS FOR HIGH LEVEL, MOTOR WINDING TEMPERATURE, AND MOTOR MOISTURE INGRESS.

> DUPLEX PUMP BLOCK DIAGRAM SCALE: NTS


\_\_16C #14 AWG TECK 90

CLASS I DIVISION 1

JUNCTION BOX

CORROSION RESISTANT

(CLASS I, DIV 1)

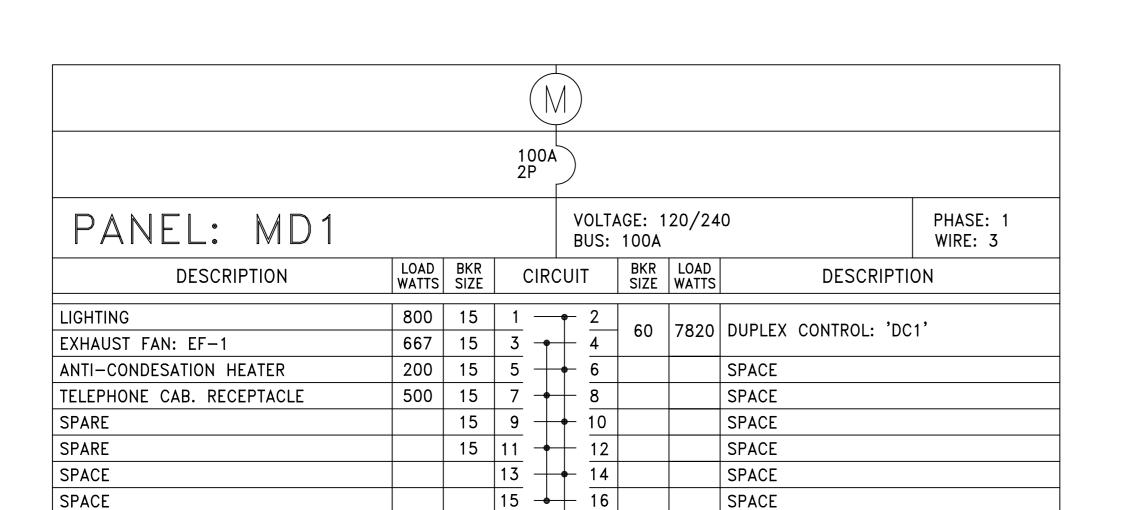

0.8 kW MOT.

0.7 kW | LTG.

SPACE

BASE DETAIL

## GENERAL NOTES


- I. CONFIRM ALL ELECTRICAL REQUIREMENTS WITH ALL DRAWINGS AND SPECIFICATIONS. PROVIDE ALL ELECTRICAL CONNECTIONS AS SPECIFIED THEREIN.
- 2. WIRING AND INSTALLATION METHODS SHALL COMPLY WITH ALL CODES AND STANDARDS TO SUIT THE AREA CLASSIFICATION INDICATED.
- 3. PROVIDE ALL DEVICES/ITEMS SHOWN HEREIN, PLUS ANY ADDITIONAL ACCESSORIES AS REQUIRED FOR A COMPLETE INSTALLATION.
- 4. PROVIDE CLASS I, DIV. 1 SEALS AT THE CABLE ENTRY POINTS INTO THE EXTERIOR PANELS / ENCLOSURES FOR ALL CABLES WHICH ENTER THE PUMPING STATION.

#### CONCRETE NOTES

- 1. CONCRETE: TO CSA A23.1 LATEST EDITION, 30MPA TYPE 50 CEMENT, 20mm AGREGATE, 5-8% AIR.
- 2. REINFORCING STEEL: TO CSA G30.18 LATEST EDITION, GRADE 400W.
- 3. STRUCTURAL STEEL: TO CSA G40.21, LATEST EDITION, GRADE 300W OR 350W.

### SPECIFIC NOTES


PROVIDE SAK4 TERMINAL BLOCKS C/W ALL ACCESSORIES (SUCH AS MOUNTING RAIL, END BLOCKS, ETC), TERMINATE 6C#14 AWG ON TERMINAL BLOCKS FROM DUPLEX PUMP CONTROLLER HIGH LEVEL ALARM (ACTIVATED THROUGH FLOAT #4) RELAY OUTPUT ALARM, MOTOR WINDING TEMPERATURE ALARM, AND MOTOR MOISTURE ALARM CONTACTS.

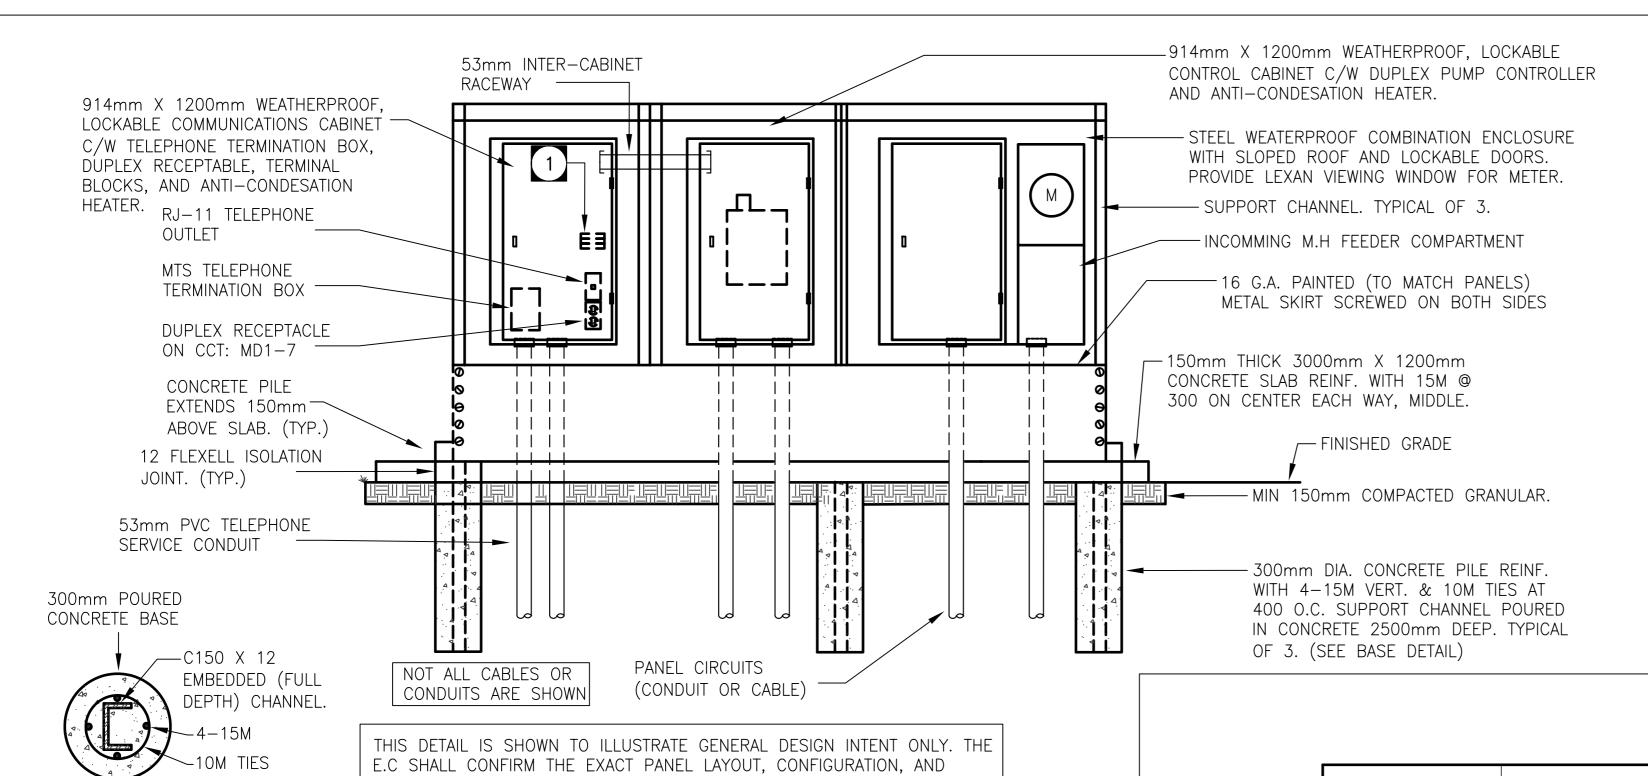

SPACE

8487 kW TOTAL

10 kW

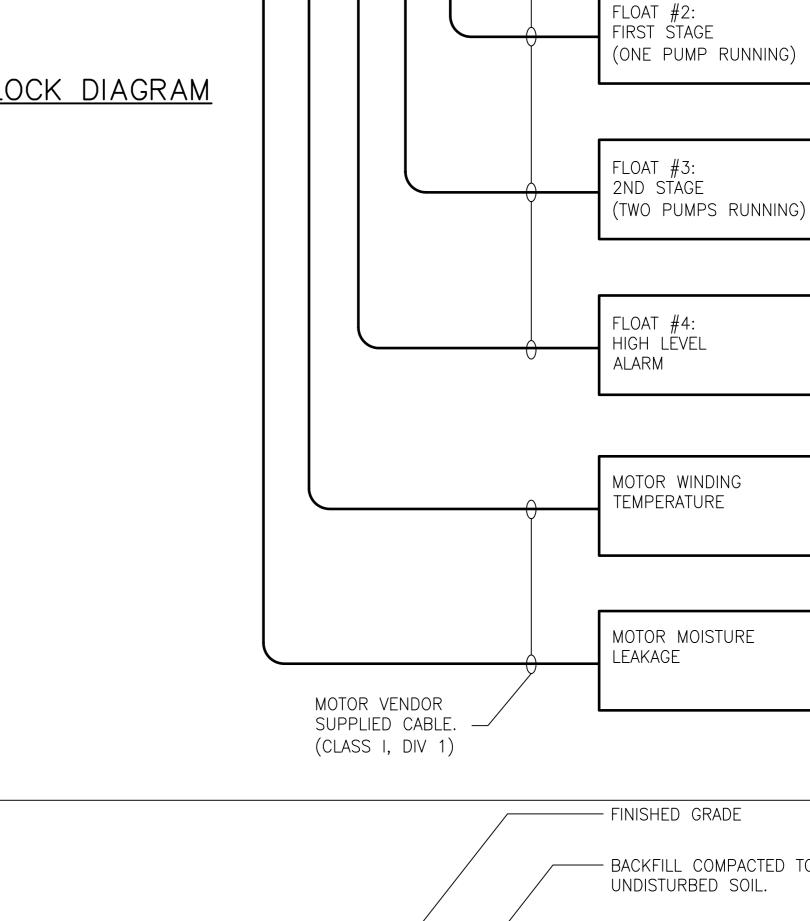


FLOAT VENDOR -SUPPLIED CABLE

(CLASS I, DIV 1)

FLOAT #1:

LOW LEVEL

(PUMPS OFF)

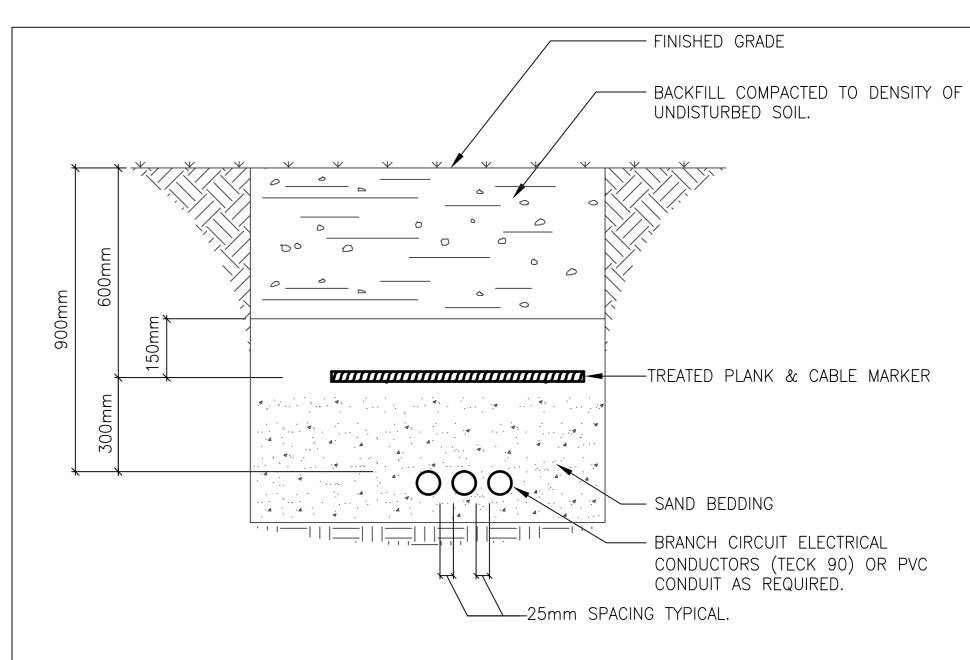

### BRANCH CIRCUIT TRENCH DETAIL SCALE: NTS

**EAPEGIN** Certificate of Authorization SNC-Lavalin Engineers & Constructors Inc. (MB) No. 2365 Expiry: April 30, 2006

B.M. ELE		FIELD BOOK #:		CII				ENGINEER'S SEAL	
POSTED TO LBIS			WATIER AINID WASTIE ENGINEERING DIVISION			ORIGINAL SIGNED			
					DESIGNED BY	DEB	CHECKED BY	EMR	E.M.RYCZKOWSKI 09/22/05
					DRAWN BY	DEB	APPROVED BY	EMR	
2	ISSUED FOR TENDER		09/22/05	EMR	HOR. SCALE	1:100	RELEASED FOR CONSTRUCTION		
1	ISSUED FOR OWNER REV		09/14/05		VERTICAL	1:100			BID OPPORTUNITY: 576-2005 FILENAME: Crescent E4.dwg

2005 09 29 DATE

DATE BY

# Winnipeg RIGINAL SIGNED .M.RYCZKOWSKI

PLOT DATE: 2005 09 29

# THE CITY OF WINNIPEG WATER AND WASTE DEPARTMENT

2005 CRESCENT DRIVE WASTEWATER SEWER SHEET 9 OF 9 AND PUMPING STATION CONSTRUCTION WASTEWATER PUMPING STATION ELECTRICAL SCHEDULES AND DETAILS

CITY DRAWING NUMBER

05696

WEATHERPROOF PANEL / CONTROL CABINET ENCLOSURES SCALE: NTS

REQUIREMENTS WITH THE MANUFACTURER. PROVIDE STANDARD ORDER

PROVIDE APPROVED CUSTOM BUILT PANEL/METER CENTER/CABINET.

EQUIPMENT ITEMS FROM CUTLER HAMMER, SQUARE D, SCHNEIDER, AND