


Size Circle Radius
Of Tree Void to Suit

Corner of Property Lines

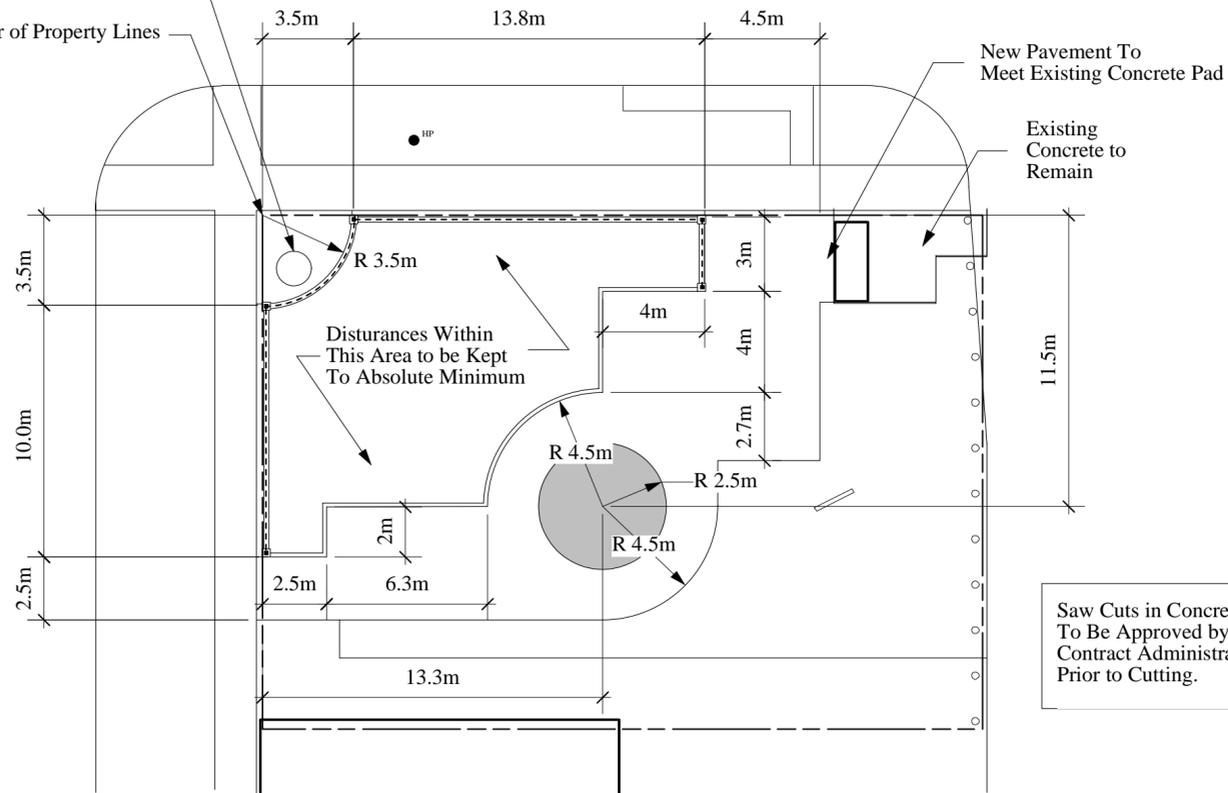

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This drawing shall not be used for building purposes until countersigned by the Landscape Architect.

The contractor shall check all dimensions and other data on site and report any discrepancies to the Landscape Architect.

Figured dimensions to be taken in preference to scaled dimensions.

If in doubt please ask.

DATE ISSUED
Aug. 9, 2004

LOCATION OF UNDERGROUND STRUCTURES AS SHOWN ARE BASED ON THE BEST INFORMATION AVAILABLE BUT NO GUARANTEE IS GIVEN THAT ALL EXISTING UTILITIES ARE SHOWN OR THAT THE GIVEN LOCATIONS ARE EXACT. CONFIRMATION OF EXISTENCE AND EXACT LOCATION OF ALL SERVICES MUST BE OBTAINED FROM THE INDIVIDUAL UTILITIES BEFORE PROCEEDING WITH CONSTRUCTION.

NOTE: DO NOT SCALE - DRAWING PLOT MAY NOT BE AT 100%


1
L11

Layout Plan

1:200




Manager Parks and Open Space Division
Released For Construction Date

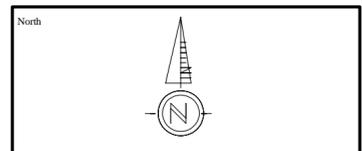

Project
Nellie McClung Park
Winnipeg, Manitoba

Sheet Title
Layout Plan and Grading Plan

| | |
|-----------------------|---------------------------|
| Drawn LLW | Approved |
| Date July 19, 2004 | Scale 1:200 m |
| Job No. 0405-4 | Drawing No. L11 |

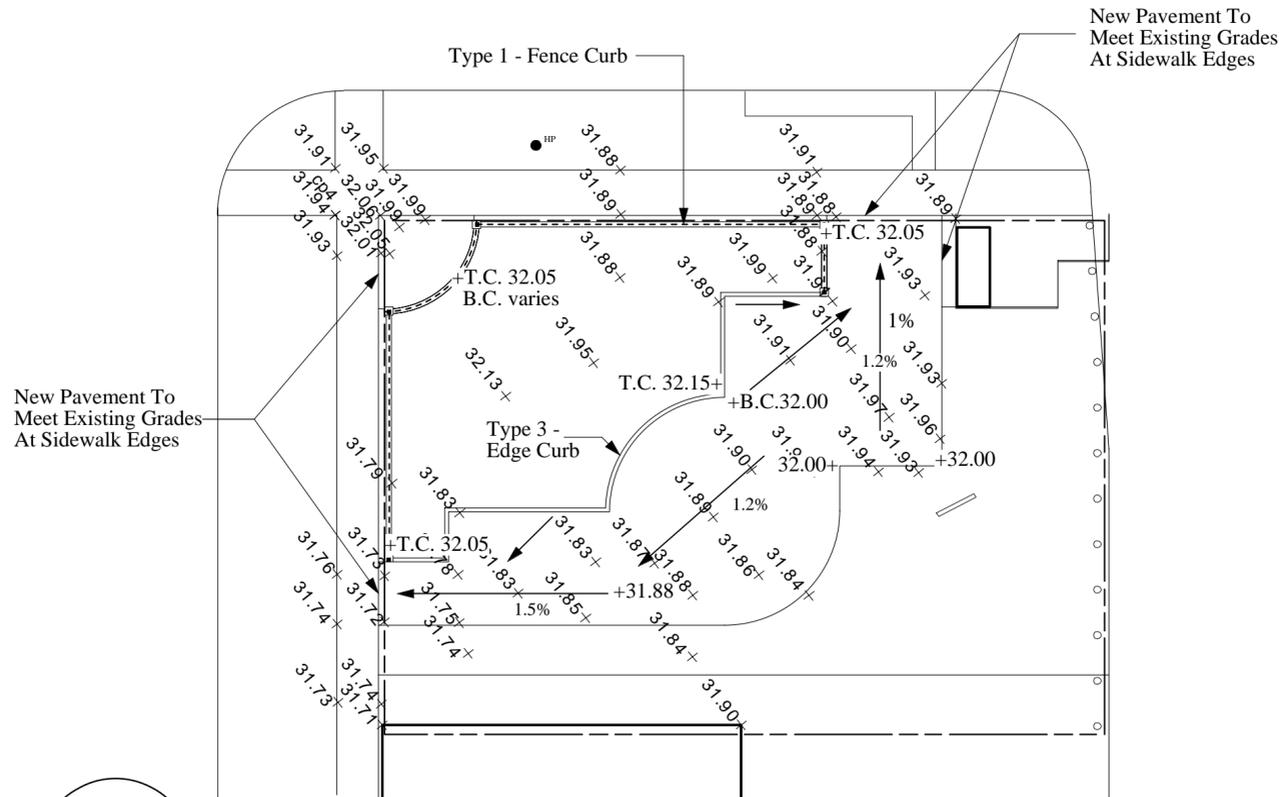

Grading Notes:

1. Retain existing grades around all existing trees. Do not damage tree roots.
2. New paving to meet flush with existing paving.
3. Adjust grades in existing turf areas to meet new paving.
4. Top of Fence Curb to be level along entire length. Edge curb to follow grade of paving.
5. All grades shown in metric.

Grading Legend:

- 31.93+ Existing Elevations
- + 32.46 Proposed Elevations
- T.C. Top of Curb
- B.C. Bottom of Curb

2
L11

Grading Plan

1:200

